ARCHE DRAWINGS

WD-01 NS GENERAL NOTES WD-02 SITE PLAN BWD-03 DI GROUND FLOOR PLAN

WD-04 FIRST FLOOR PLAN WD-05 SECOND FLOOR PLAN ROOFPLAN WD-08 2<u>ELEVATIONS31</u>7699357

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BSSECTION B/DETAILS WD-11 SECTION D,E,F WD-19LOOD PRDAIESAREA

WD-13 DETAILS SECTION G, H & DETAIL WD-14

WD-15 WET AREA DETAILS WD-16 WET AREA DETAILS

WD-17 **GROUND F. LIGHTING PLANS** WD-18 FIRST AND SECOND F. LIGHTING PLANS

WD-19 WINDOW SCHEDULE WD-20 SPECIFICATIONS

STRUCTURAL & **CIVIL ENGINEER**

SUNNY ENGINEERING EMAIL: mdgroup168@gmail.com PH: (07) 0405325828 JOB No: 11413 DATE: APRIL-18

GEO-TECHNICAL

SOUTHERN CROSS SOIL TESTING 10 CENTAURUS AVENUE, ROXBURGH PARK VIC 3064 PH: (03) 9308 8031 DATE: 26-03-2018

SITE CLASSIFICATION AS CLASS: REFER TO SOIL REPORT NO:

230318.tb

GENERAL NOTES (NCC 2019 BCA VOL 2)

ALL MATERIALS AND WORK PRACTICES SHALL COMPLY WITH, BUT NOT LIMITED TO THE BUILDING REGULATIONS 2018, NATIONAL CONSTRUCTION CODE SERIES 2019 BUILDING CODE OF AUSTRALIA VOL 2 AND ALL RELEVANT CURRENT AUSTRALIAN STANDARDS (AS AMENDED) REFERRED TO THEREIN.

UNLESS OTHERWISE SPECIFIED, THE TERM BCA SHALL REFER TO NATIONAL CONSTRUCTION CODE SERIES 2019 BUILDING CODE OF AUSTRALIA VOLUME 2.

ALL MATERIALS AND CONSTRUCTION PRACTICE SHALL MEET THE PERFORMANCE REQUIREMENTS OF THE BCA. WHERE A PERFORMANCE SOLUTION IS PROPOSED THEN, PRIOR TO IMPLEMENTATION OR INSTALLATION, IT FIRST MUST BE ASSESSED AND APPROVED BY THE RELEVANT BUILDING SURVEYOR AS MEETING THE PERFORMANCE REQUIREMENTS OF THE BCA.

GLAZING, INCLUDING SAFETY GLAZING, SHALL BE INSTALLED TO A SIZE, TYPE AND THICKNESS SO AS TO COMPLY WITH:

- BCA PART 3.6 FOR CLASS 1 AND 10 BUILDINGS WITHIN A DESIGN WIND SPEED OF NOT MORE THAN N3; AND
- BCA VOL 1 PART B1.4 FOR CLASS 2 AND 9

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WATERPROOFING OF WET AREAS, BEING BATHROOMS, SHOWERS, SHOWER ROOMS, LAUNDRIES, SANITARY COMPARTMENTS AND THE LIKE SHALL BE PROVIDED IN ACCORDANCE WITH AS 3740-2010: WATERPROOFING OF DOMESTIC WET AREAS.

THESE DRAWINGS SHALL BE READ IN CONJUNCTION WITH ANY HOUSE ENERGY RATING (HERS) REPORT AND SHALL BE CONSTRUCTED IN ACCORDANCE WITH THE STAMPED PLANS ENDORSED BY THE ACCREDITED THERMAL PERFORMANCE ASSESSOR WITHOUT ALTERATION.

STEP SIZES (OTHER THAN FOR SPIRAL STAIRS) TO BE:

- RISERS (R) 190MM MAXIMUM AND 115MM MINIMUM
- GOING (G) 355MM MAXIMUM AND 240MM MINIMUM
- 2R + 1G = 700MM MAXIMUM AND 550MM MINIMUM WITH LESS THAN 125MM GAP BETWEEN OPEN TREADS.

ALL TREADS, LANDINGS AND THE LIKE TO HAVE A SLIP-RESISTANCE CLASSIFICATION OF P3 OR R10 FOR DRY SURFACE CONDITIONS AND P4 OR R11 FOR WET SURFACE CONDITIONS, OR A NOSING STRIP WITH A SLIP-RESISTANCE CLASSIFICATION OF P3 FOR DRY SURFACE CONDITIONS AND P4 FOR WET SURFACE CONDITIONS.

PROVIDE BARRIERS WHERE CHANGE IN LEVEL EXCEEDS 1000MM ABOVE THE SURFACE BENEATH LANDINGS, RAMPS AND/OR TREADS. BARRIERS (OTHER THAN TENSIONED WIRE BARRIERS) TO BE:

- 1000MM MIN. ABOVE FINISHED SURFACE LEVEL OF BALCONIES, LANDINGS OR THE LIKE, AND
- 865MM MIN. ABOVE FINISHED SURFACE LEVEL OF STAIR NOSING OR RAMP, AND
- VERTICAL WITH LESS THAN 125MM GAP BETWEEN, AND
- ANY HORIZONTAL ELEMENT WITHIN THE BARRIER BETWEEN 150MM AND 760MM ABOVE THE FLOOR MUST NOT FACILITATE CLIMBING WHERE CHANGES IN LEVEL EXCEEDS 4000MM ABOVE THE SURFACE BENEATH LANDINGS, RAMPS AND/OR TREADS

WIRE BARRIER CONSTRUCTION TO COMPLY WITH NCC 2019 BCA PART 3 9 2 TABLE 3 9 2 1 OR TABLE 3 9 2

U3 (FROM GROUND FLOOR TO FIRST FLOOR) RISE:-176.47mm 187.5mm

RUN: -250mm 250mm 2R+G: -602.94mm 625mm

TOP OF HAND RAILS TO BE MINIMUM 865MM VERTICALLY ABOVE STAIR NOSING AND FLOOR SURFACE OF RAMPS.

WINDOW SIZES NOMINATED ARE NOMINAL ONLY. ACTUAL SIZE MAY VARY ACCORDING TO MANUFACTURER. WINDOWS TO BE FLASHED

ALL STORMWATER TO BE TAKEN TO THE LEGAL POINT OF DISCHARGE TO THE RELEVANT AUTHORITIES APPROVAL.

THESE DRAWINGS SHALL BE READ IN CONJUNCTION WITH ALL RELEVANT STRUCTURAL AND ALL OTHER CONSULTANTS' DRAWINGS/DETAILS AND WITH ANY OTHER WRITTEN INSTRUCTIONS ISSUED IN THE COURSE OF THE CONTRACT.

SITE PLAN MEASUREMENTS IN METRES - ALL OTHER MEASUREMENTS IN MILLIMETRES UNLESS NOTED OTHERWISE.

FIGURED DIMENSIONS TAKE PRECEDENCE OVER SCALED DIMENSIONS.

THE BUILDER SHALL TAKE ALL STEPS NECESSARY TO ENSURE THE STABILITY AND GENERAL WATER TIGHTNESS OF ALL NEW AND/OR EXISTING STRUCTURES DURING ALL WORKS.

THE BUILDER AND SUBCONTRACTORS SHALL CHECK AND VERIFY ALL DIMENSIONS, SETBACKS, LEVELS AND SPECIFICATIONS AND ALL OTHER RELEVANT DOCUMENTATION PRIOR TO THE COMMENCEMENT OF ANY WORKS, REPORT ALL DISCREPANCIES TO THIS OFFICE FOR CLARIFICATION.

INSTALLATION OF ALL SERVICES SHALL COMPLY WITH THE RESPECTIVE SUPPLY AUTHORITY REQUIREMENTS.

THE BUILDER AND SUBCONTRACTOR SHALL ENSURE THAT ALL STORMWATER DRAINS, SEWER PIPES AND THE LIKE ARE LOCATED AT A SUFFICIENT DISTANCE FROM ANY BUILDINGS FOOTING AND/ OR SLAB EDGE BEAMS SO AS TO PREVENT GENERAL MOISTURE PENETRATION, DAMPNESS, WEAKENING AND UNDERMINING OF ANY BUILDING AND ITS FOOTING SYSTEM.

THESE PLANS HAVE BEEN PREPARED FOR THE EXCLUSIVE USE BY THE CLIENT OF IKONOMIDIS REID ('THE DESIGNER') FOR THE PURPOSE EXPRESSLY NOTIFIED TO THE DESIGNER. ANY OTHER PERSON WHO USES OR RELIES ON THESE PLANS WITHOUT THE DESIGNER'S WRITTEN CONSENT DOES SO AT THEIR OWN RISK AND NO RESPONSIBILITY IS ACCEPTED BY THE DESIGNER FOR SUCH USE

A BUILDING PERMIT IS REQUIRED PRIOR TO THE COMMENCEMENT OF THESE WORKS. THE RELEASE OF THESE DOCUMENTS IS CONDITIONAL TO THE OWNER OBTAINING THE REQUIRED BUILDING PERMIT.

THE CLIENT AND/OR THE CLIENT'S BUILDER SHALL NOT MODIFY OR AMEND THE PLANS WITHOUT THE KNOWLEDGE AND CONSENT OF IKONOMIDIS REID EXCEPT WHERE A REGISTERED BUILDING SURVEYOR MAKES MINOR NECESSARY CHANGES TO FACILITATE THE BUILDING PERMIT APPLICATION AND THAT SUCH CHANGES ARE PROMPTLY REPORTED BACK TO IKONOMIDIS REID.

THE APPROVAL BY THIS OFFICE OF A SUBSTITUTE MATERIAL, WORK PRACTICE, VARIATION OR THE LIKE IS NOT AN AUTHORISATION FOR ITS USE OR A CONTRACT VARIATION. ALL VARIATIONS MUST BE ACCEPTED BY ALL PARTIES TO THE AGREEMENT AND WHERE APPLICABLE THE RELEVANT BUILDING SURVEYOR PRIOR TO IMPLEMENTING ANY VARIATION.

STORMWATER

150 MM DIA. CLASS 6 UPVC STORMWATER LINE LAID TO A MINIMUM GRADE OF 1:100 AND CONNECTED TO THE LEGAL POINT OF STORMWATER DISCHARGE. PROVIDE INSPECTION OPENINGS AT 9000MM C/C AND AT EACH CHANGE OF DIRECTION.

THE COVER TO UNDERGROUND STORMWATER DRAINS SHALL BE NOT LESS THAN

- 100MM UNDER SOIL
- 50MM UNDER PAVED OR CONCRETE AREAS
- 100MM UNDER UNREINFORCED CONCRETE OR PAVED DRIVEWAYS
- 75MM UNDER REINFORCED CONCRETE DRIVEWAYS

WALL TYPES

90mm MGP10 TIMBER FRAME WALL AS PER SPEC 240mm BRICK VENEER WALL AS PER SPEC

230mm BRICK WALL WITH ENGAGED PIERS ON ONE SIDE AS PER SPEC & AS 4773.1

WALL CONSISTING OF:

90mm STUD WITH 'MASTERWALL' 75mm THICK EXTERNAL CLADDING SYSTEM WITH RENDER FINISH OVER - BUILDER TO PROVIDE APPROVED SYSTEM APPLICATION DETAILS TO RELEVANT BUILDING SURVEYOR FOR APPROVAL PRIOR TO INSTALLATION.



- CAVITY INSULATION R 2.0 GW WALL BATTS
- 20mmmm SEPARATION BETWEEN FRAME AND FIRE BARRIER
- 25mm SHAFT LINER PANEL BETWEEN 25mm H STUDS AT 600mm MAX CTRS
- 20mmmm SEPARATION BETWEEN FRAME AND FIRE BARRIER
- CAVITY INSULATION R 2.0 GW WALL BATTS
- 90mm MGP10 TIMBER FRAME WALL AS PER SPEC - 1x 13mm SOUNDSTOP WALL LINING

(TO ACHIEVE FRL 60/60/60 & Rw + Ctr 55)

REFER TO MANUFACTURERS INFORMATION FOR DETAILS

BORAL OUTRWALL 60 WALL SYSTEM (FRL 60/60/60) - FROM OUTSIDE ONLY

CONSISTING OF:-

- JAMES HARDIE 7.5mm THICK, 'HARDIETEX' EXTERNAL FC CLADDING (NON-COMBUSTIBLE) FIXED TO TIMBER BATTENS TO MANUFACTURES SPECIFICATIONS WITH RENDER FINISH OVER
- VERTICAL OR HORIZONTAL BATTENS FIXED TO STUDS AT 600mm MAXIMUM
- 1X16mm WET AREA FIRESTOP AS PER SYSTEM TS3
- TYVEK HOMEWRAP STAPLED TO PLASTERBOARD AS PER MANUFACTURES
- 90mm MGP10 TIMBER FRAME WALL AS PER SPEC TO INTERNAL FACE OF



WALL CONSISTING OF: 90mm STUD WITH HARDIEWRAP WEATHER BARRIER JAMES HARDIE 9mm THICK 'AXON' EXTERNAL CLADDING - BUILDER TO PROVIDE APPROVED SYSTEM APPLICATION DETAILS TO RELEVANT BUILDING SURVEYOR FOR APPROVAL PRIOR TO INSTALLATION.



MIN. 6mm THICK CEMENT BOARD CLADDING WITH RENDER OF CHOICE OR 15mm THICK TIMBER CLADDING, 90mm TIMBER STUD WITH R2.5 ACOUSTIC FIBREOUS BATTS AND 10mm STANDARD PLASTERBOARD TO THE INTERNAL SIDE OF WALL. REFER TO ACOUSTIC REPORT FOR FURTHER INFO



MIN. 6mm THICK CEMENT BOARD CLADDING WITH RENDER OF CHOICE OR 15mm THICK TIMBER CLADDING, 90mm TIMBER STUD WITH R2.5 ACOUSTIC FIBREOUS BATTS AND 13mm SOUND REDUCING PLASTERBOARD TO THE INTERNAL SIDE OF WALL. REFER TO ACOUSTIC REPORT FOR FURTHER INFO

LEGEND

BIR BUILT IN ROBE

WASHING MACHINE / DRYER OVER BY OTHERS PROVIDE PLUMBING & POWER

PROVIDE WASTE OUTLET NEAR WASHING MACHINE LAUNDRY TROUGH

DISHWASHER BY OTHERS PROVIDE PLUMBING & POWER DW

HOT PLATE WITH RANGEHOOD OVER & UNDERBENCH OVEN DUCT RANGE HOOD EXHAUST DIRECTLY TO EXTERNAL AIR

STAINLESS STEEL SINK

REFRIGERATOR BY OTHERS

PANTRY

900mm x 900mm SHOWER BASE TO BUILDER'S SELECTION SH NOT TO BE CUT INTO LOAD BEARING WALLS

900mm x 1500mm SHOWER BASE TO BUILDER'S SELECTION NOT TO BE CUT INTO LOAD BEARING WALLS

900mm x 1650mm SHOWER BASE TO BUILDER'S SELECTION NOT TO BE CUT INTO LOAD BEARING WALLS

900mm x 1710mm SHOWER BASE TO BUILDER'S SELECTION NOT TO BE CUT INTO LOAD BEARING WALLS

VANITY UNIT TO OWNER'S SELECTION

WALL VANITY UNIT TO OWNER'S SELECTION

TOILET SUITE TO OWNER'S SELECTION

DP DOWN PIPE AS PER SPEC

BG BOX GUTTER AS PER SPEC

RWH RAIN WATER HEAD AS PER SPEC

SPD SPREADER AS PER SPEC

SUMP SUMP AS PER SPEC

OVERHEAD CUPBOARD

LOH LIFT OFF HINGES

HWS HOT WATER SERVICE TO BUILDERS SELECTION ENSURE GAS HOT WATER SERVICES ARE 500mm AWAY FROM AN OPENABLE WINDOW SASH OR DOOR

DENOTES LOCATION OF SMOKE ALARMS TO BE PROVIDED AND INSTALLED IN ACCORDANCE WITH AS 3786-1993. THE SMOKE ALARM SHALL BE HARD WITH A BATTERY BACKUP - ENSURE ALL SMOKE DETECTORS TO BE

CEILING MOUNTED EXHAUST FAN 250mm DIA. 140I/S MIN. DISCHARGING INTO VENTILATED ROOF SPACE WITH A MIN. 1m HORIZONTAL LENGTH DUCT OR DIRECT TO OUTSIDE AIR IN ACCORD. WITH AS 1668- FITTED WITH SELF CLOSERS

> MULTI UNIT DEVELOPMENT 154 BROADWAY RESERVOIR

WD-01

Job No. 009984 SCALE. DRAWN. DATE.

GENERAL NOTES

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OCT 19 BUILDING SURVEYOR CHECKLIST A JAN 19 BUILDING PERMIT ISSUE REV DATE ISSUE


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SITE PREPARATION NOTES:

ALL VEGET. & CONC. PAVING TO BE REMOVED FROM AREA OF CONSTRUCTION. ANY FILLING UNDER PAVING SLABS TO BE FCR., GRADE 2A MATERIAL OF 50mm (MAX SIZE COMPACTED IN 200mm THICK (MAX) LAYERS TO GIVE 100% STANDARD COMPACTION. GRADE UNIFORMLY BETWEEN GIVEN LEVELS

SITE PLAN NOTES

ALL FRC, RCP, EW & SEWER QUALITY PVC PIPES UNDER TRAFFICABLE PAVING TO HHAVE 450mm MIN. COVER. STORMWATER QUALITY PVC PIPES TO HAVE 600mm MIN. COVER, ALL PIPES IN GARDEN AREAS TO HAVE 300mm COVER

DEMOLITION NOTES
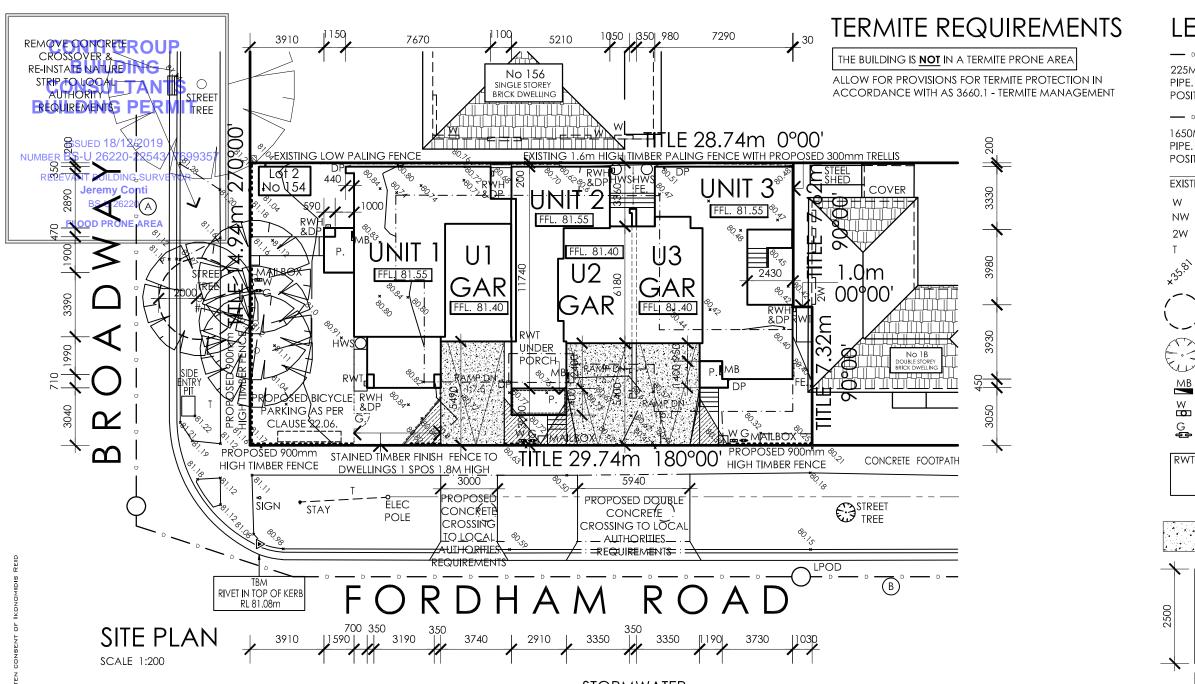
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EXISTING CONCRETE DRIVEWAY AND HOUSE TO BE REMOVED - SHOWN DOTTED. ASBESTOS AUDIT TO BE CARRIED OUT BY BUILDER PRIOR TO ANY DEMOLITION. ANY ASBESTOS SHALL BE REMOVED AS PER THE REQUIREMENTS OF THE OCCUPATIONAL HEALTH AND SAFETY CODE OF PRACTICE

LAND SURVEY

REFER TO RE-ESTABLISHMENT SURVEY BY: JRL

REF No: 16-257 D1 DATE: 01.11.2016

FENCING

ALL INTERNAL FENCING BETWEEN UNITS TO BE 1.8M HIGH PALING FENCE & GATES WHERE NOTED

PLANNING PERMIT

REFER TO PLANNING PERMIT D/49/2017 ISSUED BY DAREBIN CITY COUNCIL ON THE 8 JANUARY 2018 FOR ALL CONDITIONS.

SERVICES

BUILDER TO ALLOW FOR CONNECTION OF ALL REQUIRED SERVICES

- WATER SUPPLY SEWERAGE - GAS - DRAINAGE
- ELECTRICITY

ALL PLUMBING & EXTERNAL SERVICES ON EXTERNAL WALL (EXCEPT DOWN PIPES) SHALL BE CONCEALED WITHIN THE WALLS

STORMWATER

- ROOFING AS PER SPEC. FIX ROOFING IN ACCORDANCE WITH MANU. SPEC. AND INSULATION AS PER SPEC.

- PROVIDE ALL COLORBOND FLASHINGS AS REQUIRED TO PROVIDE A WATERTIGHT INSTALLATION.

- CONNECT ALL NEW DOWNPIPES TO LEGAL POINT OF DISCHARGE AS PER ENGINEERS DRAWINGS

- EAVES GUTTERS AS PER SPEC. MIN 1:200 FALL TOWARDS DOWNPIPES

- BOX GUTTER AS PER SPEC. MIN 1:200 FALL TOWARDS OUTLET

- ALL DOWNPIPES AS PER SPEC

- ALL MECHANICAL AND OTHER SERVICE PENETRATIONS THROUGH ROOF SHALL BE FULLY FLASHED AND MADE WATERTIGHT

LANDSCAPING

REFER TO SEPARATE LANDSCAPE PLAN BY: KEYSTONE ALLIANCE PTY LTD JOB NO: L6030 REV E DATE: 18.09.2018

LEGAL POINT OF DISCHARGE

REFER TO COUNCIL INFO & APPROVED CIVIL PLAN

ENSURE ALL FINISHED GROUND SURFACES SLOPE AWAY FROM BUILDINGS

REFER TO ENG'S DETAILS & SOIL REPORT FOR REQUIREMENTS IN FOOTINGS & BUILDING OVER REMOVED OR RETAINED TREES FOR THIS SITE OR ADJACENT

ENSURE NO PART OF ANY BUILDING IS TO **ENCROACH THE TITLE BOUNDARY**

PORCH / ALFRESCO MIN. 85MM & MAX 170mm BELOW FFL

REFER TO LANDSCAPE DESIGN IN CONJUNCTION WITH ENGINEERS DRAWINGS FOR ALL DETAILS RELATING TO PAVING MATERIAL, TYPE & FINISH

LEGEND

225MM Ø UNDERGROUND STORMWATER DRAIN PIPE. DEPTH AND OFFSET UNKNOWN. CONFIRM POSITION ON SITE PRIOR TO CONSTRUCTION

1650MM Ø UNDERGROUND STORMWATER DRAIN PIPE. DEPTH AND OFFSET UNKNOWN. CONFIRM POSITION ON SITE PRIOR TO CONSTRUCTION

EXISTING OVERHEAD WIRES

HABITABLE ROOM WINDOWS

NON-HABITABLE ROOM WINDOWS NW

2W SECOND STOREY HABITABLE ROOM WINDOWS

TEL PIT

EXISTING SPOT LEVELS





PROPOSED ELECTRICAL METER BOX

PROPOSED WATER METER $\dot{\omega}$

PROPOSED GAS METER

SELECTED 2000 LITRE RAINWATER TANK TO BE SERVED BY A ROOF AREA OF NO LESS THAN 175M2 CATCHMENT AREA & CONNECTED TO SANITARY FLUSHING SYSTEMS. REFER TO SDA REPORT FOR FURTHER INFO.



SELECTED CONCRETE DRIVEWAY

2000

PEDESTRIAN VISIBILITY SPLAY NOTE: PEDESTRIAN VISIBILITY SPLAYS MEASURING 2.0m (WIDTH ACROSS THE FRONTAGE BY 2.5m (DEPTH INTO SITE), TO THE NORTH & SOUTH SIDE OF THE PROPOSED CROSSOVERS TO FORDHAM ROAD WHERE WITHIN THE SUBJECT SITE, ANY STRUCTURES OR VEGETATION WITHIN THESE SPLAYS MUST NOT BE MORE THAN 1.15m IN HEIGHT.

LOCALISED CUT/FILL LEVELS TO BE DETERMINED ON SITE TO SUIT CONCRETE SLAB TO ENG'S DETAILS AND FINISHED FLOOR LEVELS

ENSURE DEEP EDGE REBATE SO AS TO NOT EXPOSE SLAB EDGE - REFER TO ENG'S DETAIL

PLANS TO BE READ IN-CONJUCTION WITH ACOUSTICS REPORT PREPARED BY AUDIOMETRIC & ACOUSTIC SERVICES DATED 18 SEP 2018

THE DEVELOPER IS RESPONSIBLE FOR THE REMOVAL OF THE STREET TREE WITH ALL WORKS TO BE UNDERTAKEN BY A SUITABLE QUALIFIED PROFESSIONAL

MULTI UNIT DEVELOPMENT 154 BROADWAY RESERVOIR

WD-DZ

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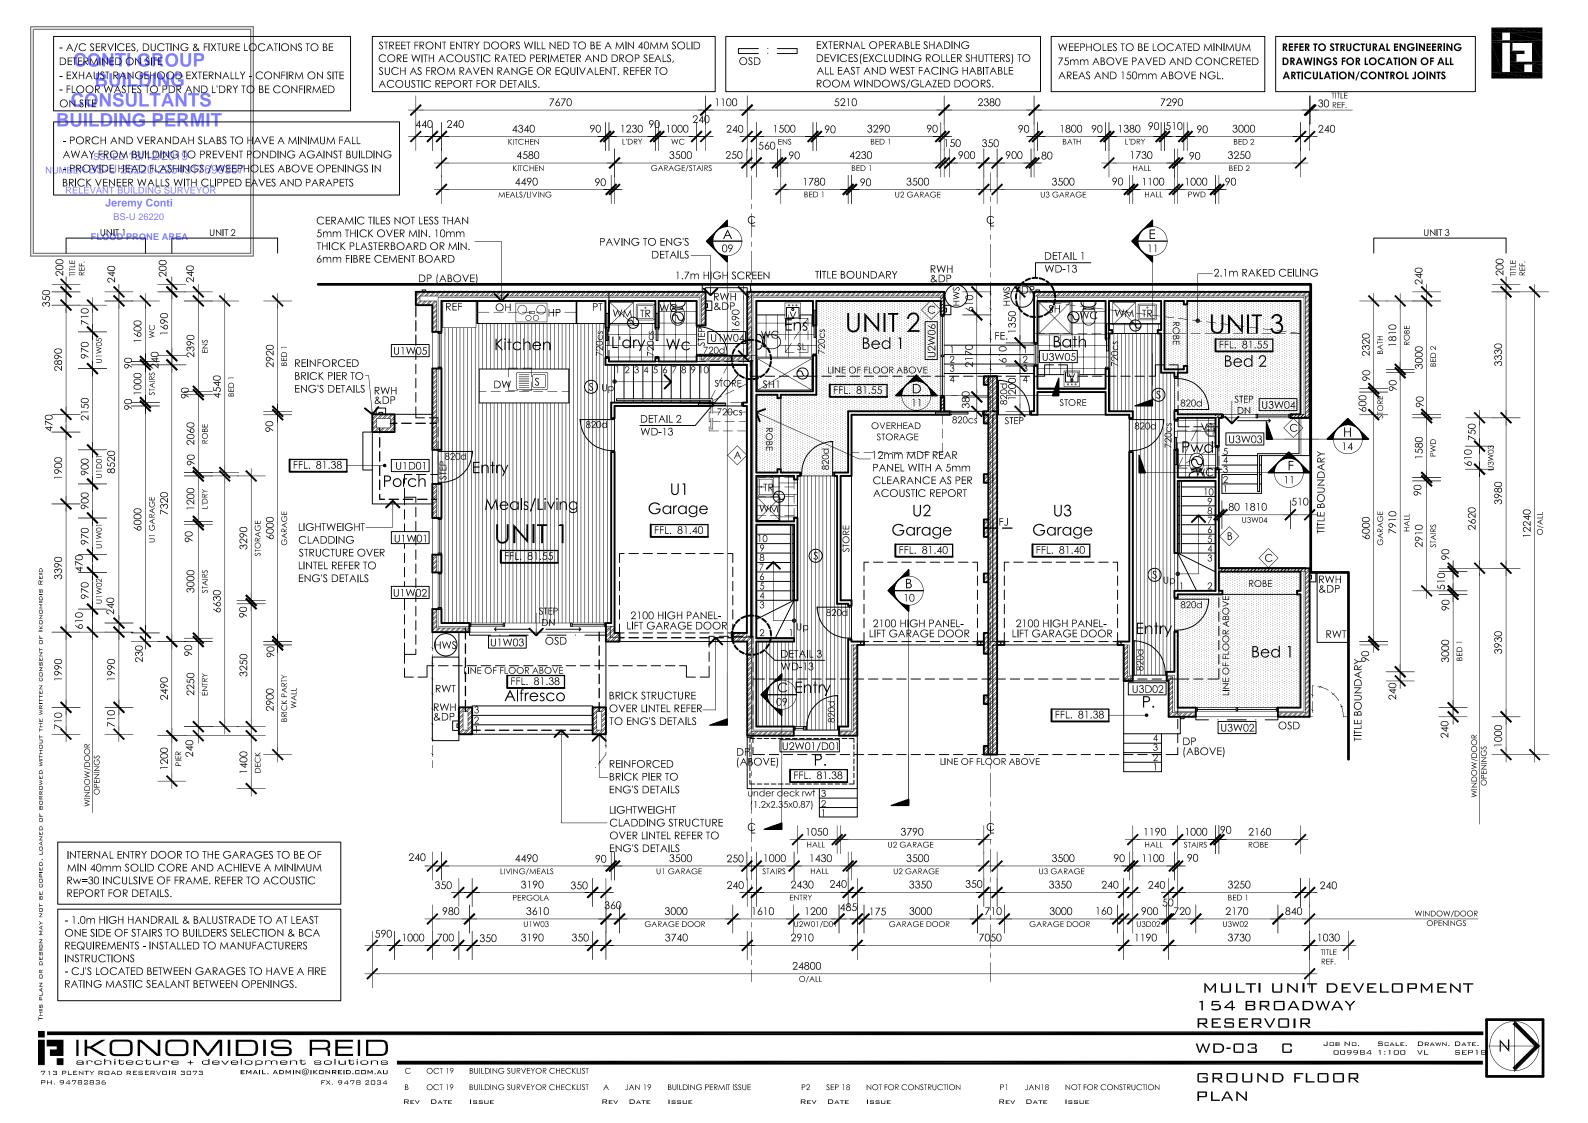
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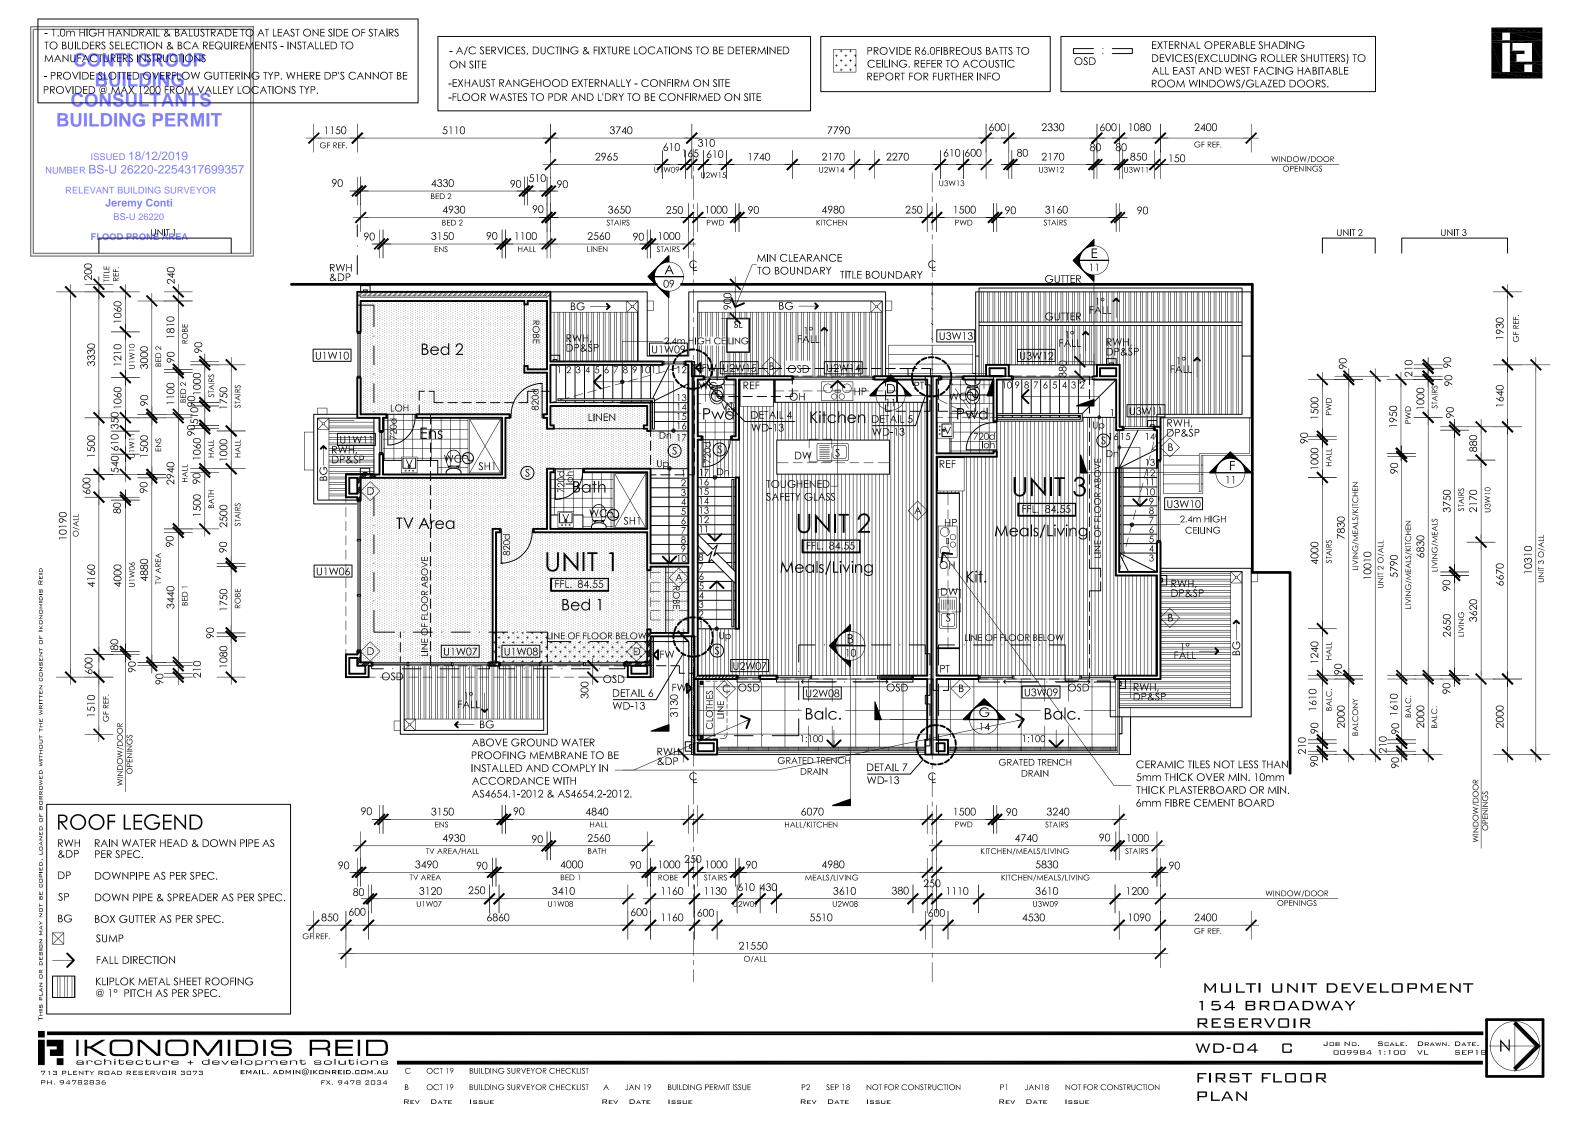
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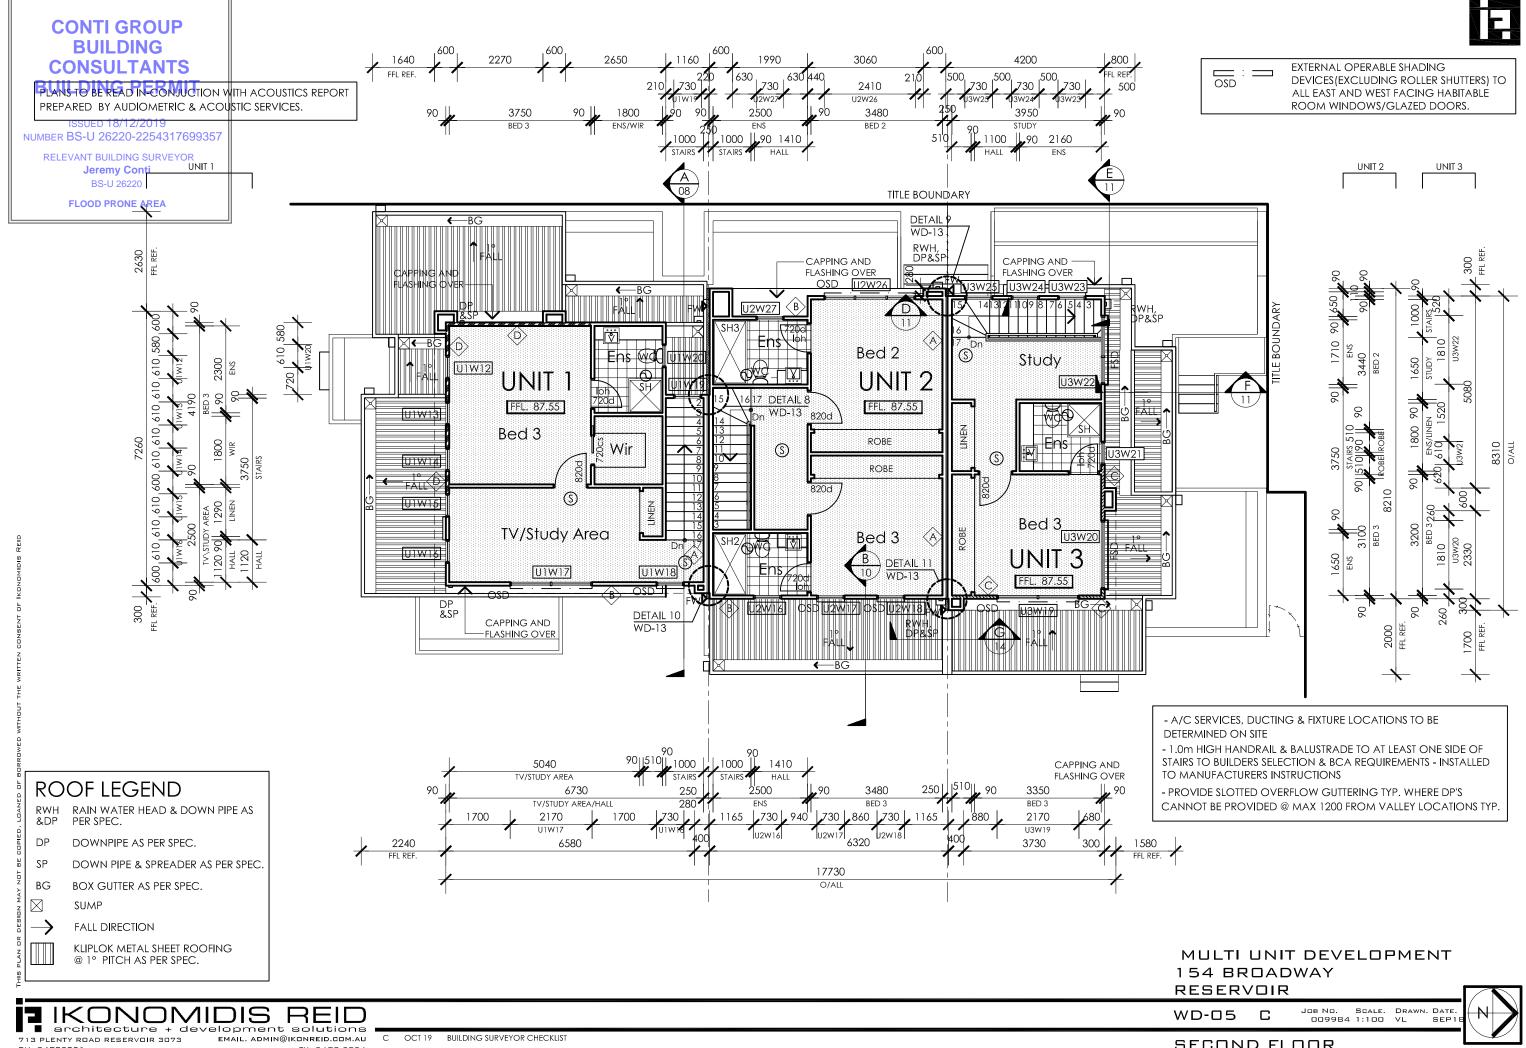
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SITE PLAN







SECOND FLOOR PLAN

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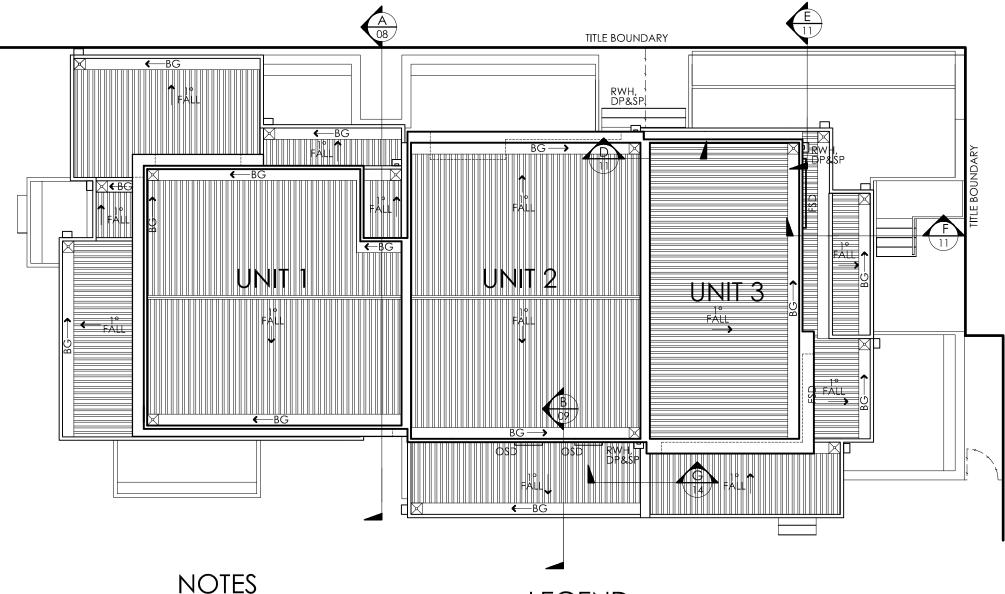
CONTI GROUP BUILDING CONSULTANTS BUILDING PERMIT

ISSUED 18/12/2019 NUMBER BS-U 26220-2254317699357

> RELEVANT BUILDING SURVEYOR **Jeremy Conti** BS-U 26220

> > FLOOD PRONE AREA





ROOFING AS PER SPEC.

FIX ROOFING IN ACCORDANCE WITH MANUFACTURER'S SPECIFICATIONS OVER SISALATION AND INSULATION AS PER SPEC.

PROVIDE ALL FLASHINGS AS REQUIRED TO PROVIDE A WEATHERTIGHT INSTALLATION. ALL FLASHING AS PER SPEC.

CONNECT ALL NEW DOWNPIPES TO LEGAL POINT OF DISCHARGE

EAVES GUTTER - COLORBOND QUAD GUTTER MINIMUM 1:100 FALL TOWARDS DOWNPIPES

ALL RAINWATER HEADS TO BE

MIN 300W X 200D X 250H COLORBOND RAINWATER HEAD OR SIMILAR TO BUILDER'S SELECTION WITH MIN 100 X 50 OVERFLOW POP

ALL DOWNPIPES 90Ø UNLESS OTHERWISE NOTED

PROVIDE COLORBOND CAPPING OVER ALL PARAPETS

ALL MECHANICAL AND OTHER SERVICE PENETRATIONS THROUGH ROOF SHEETING SHALL BE FULLY FLASHED AND MADE WATERTIGHT

LEGEND

RWH RAIN WATER HEAD & DOWN PIPE AS &DP PER SPEC.

DOWNPIPE AS PER SPEC.

SP DOWN PIPE & SPREADER AS PER SPEC.

ВG BOX GUTTER AS PER SPEC.

 \boxtimes SUMP

FALL DIRECTION

KLIPLOK METAL SHEET ROOFING @ 1° PITCH AS PER SPEC.

ALL ROOF PENETRATIONS TO BE SUITABLY FLASHED AND SEALED TO ENSURE WATERTIGHT FINISH

PROVIDE ADEQUATE OVERFLOW PROVISION TO ALL BOX GUTTERS AT ENDS THROUGH PARAPETS ETC.

> MULTI UNIT DEVELOPMENT 154 BROADWAY RESERVOIR

> > JOB NO. SCALE. DRAWN. DATE. 009984 1:100 VL SEP1

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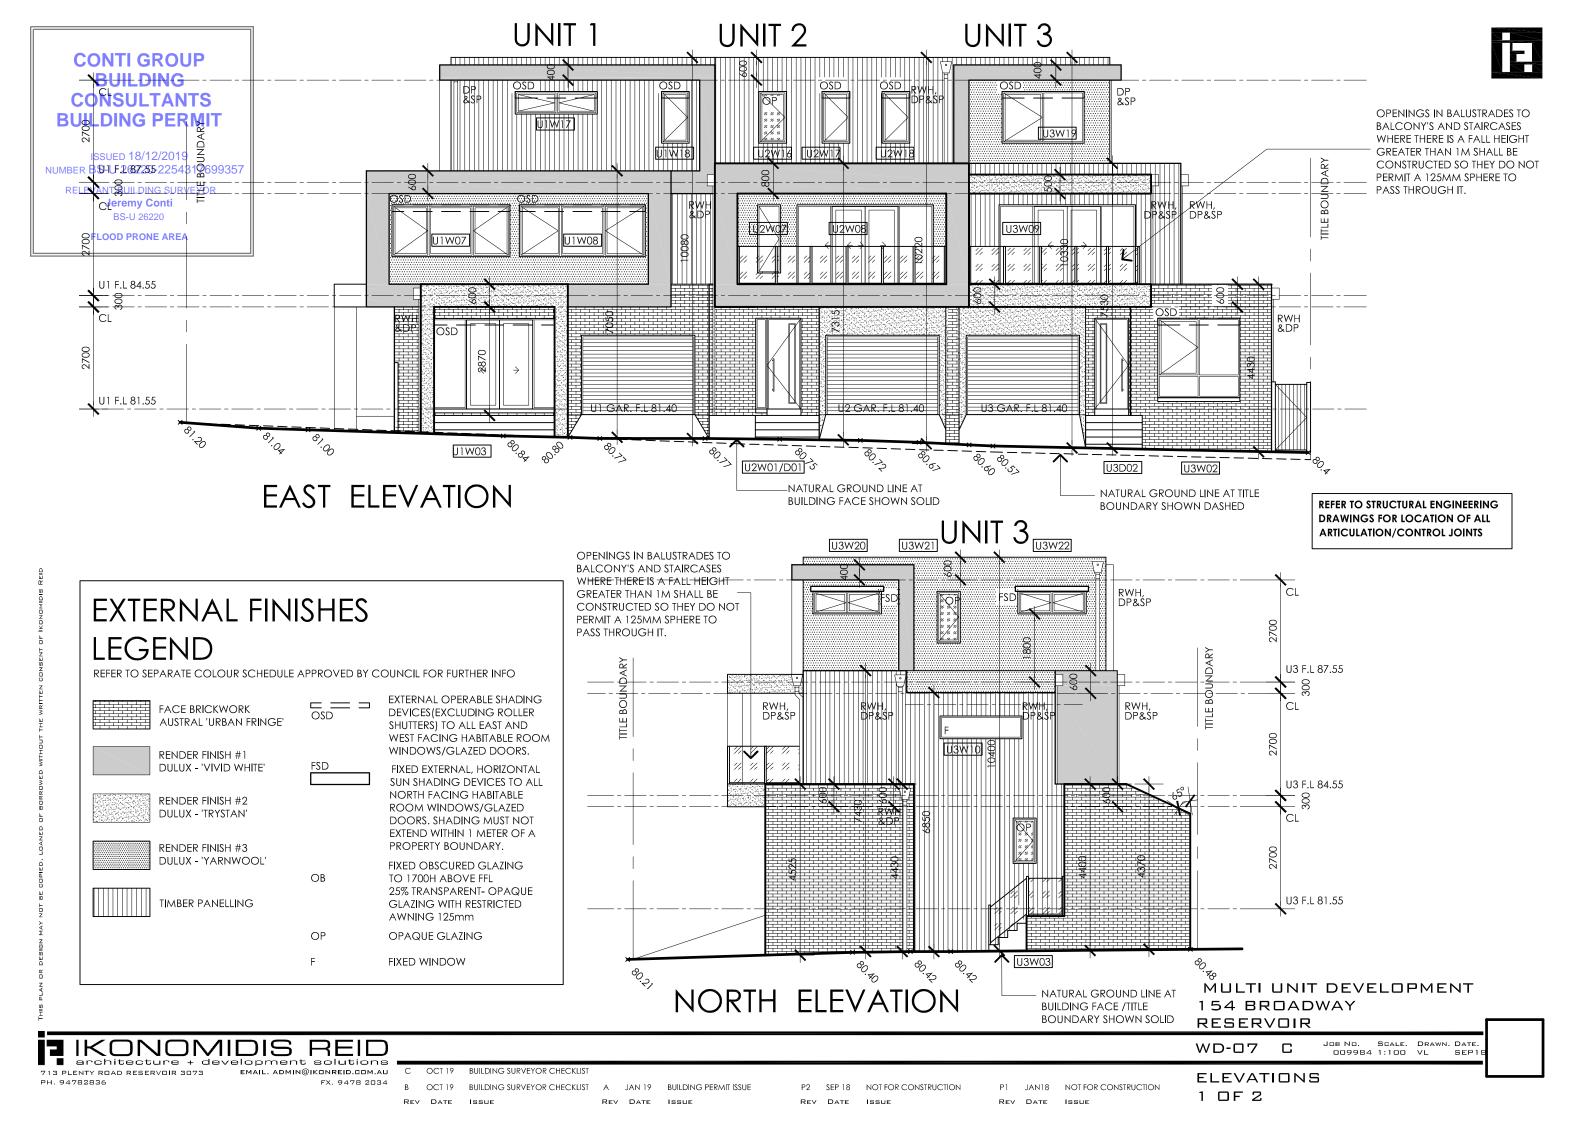
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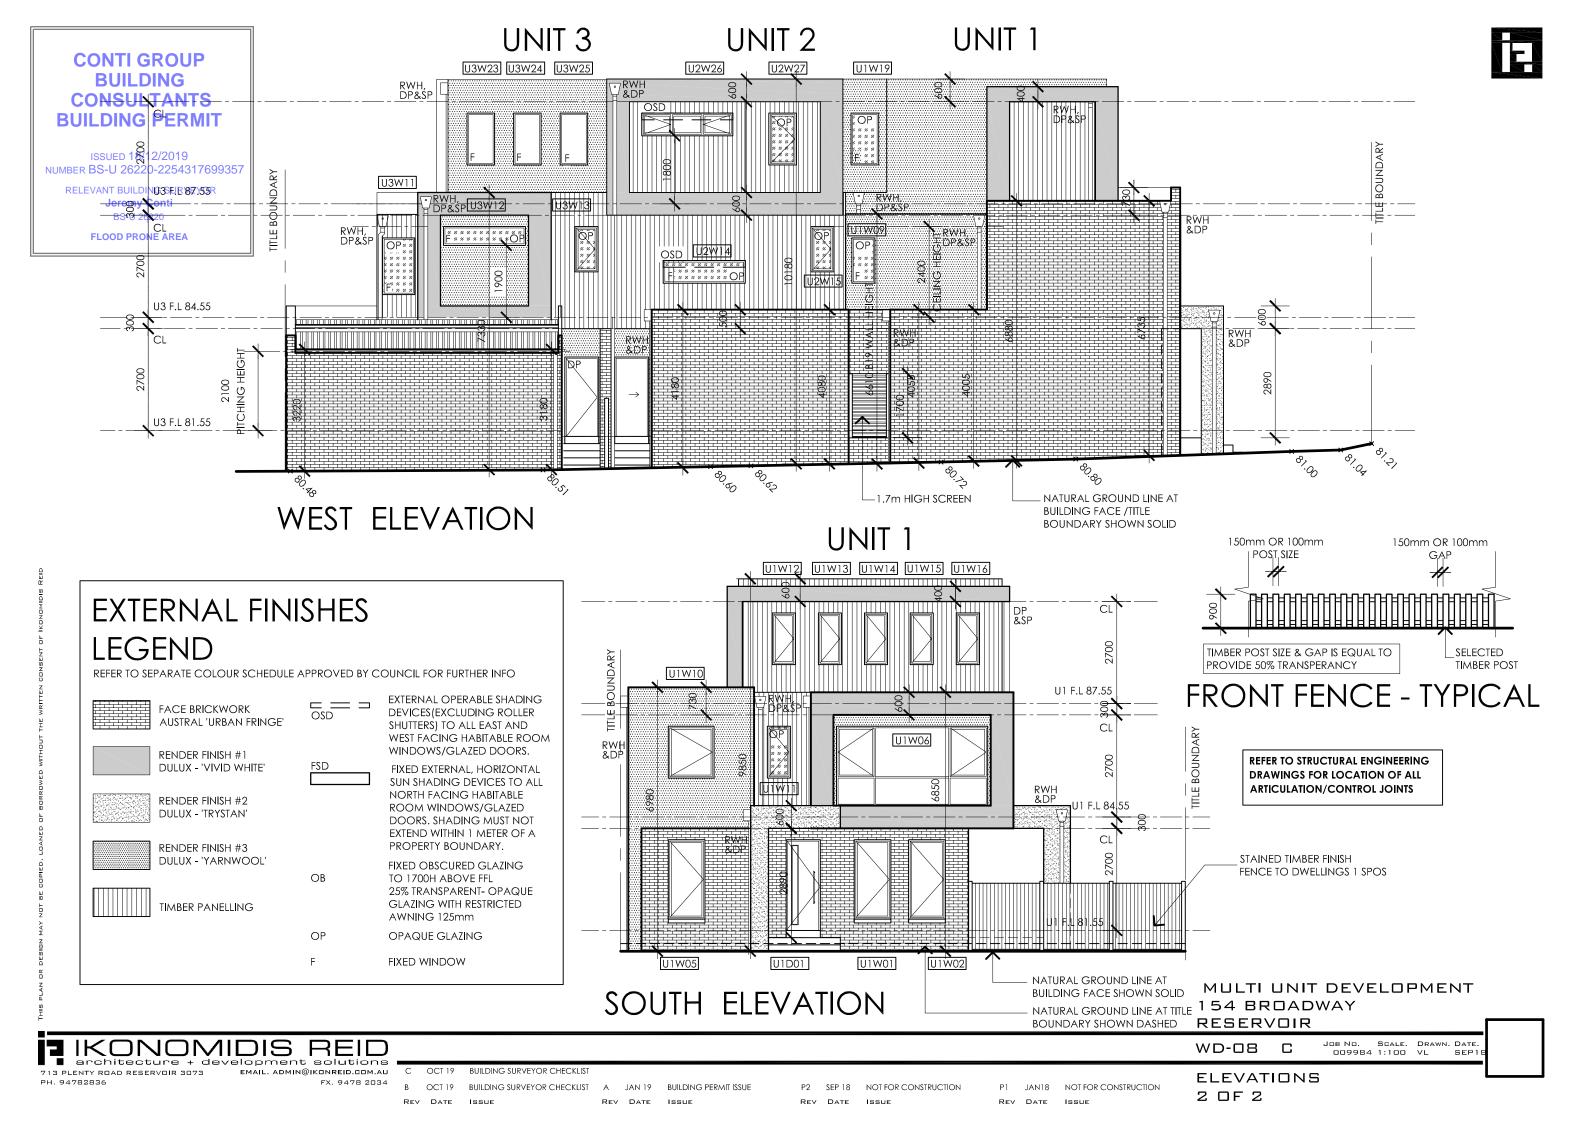
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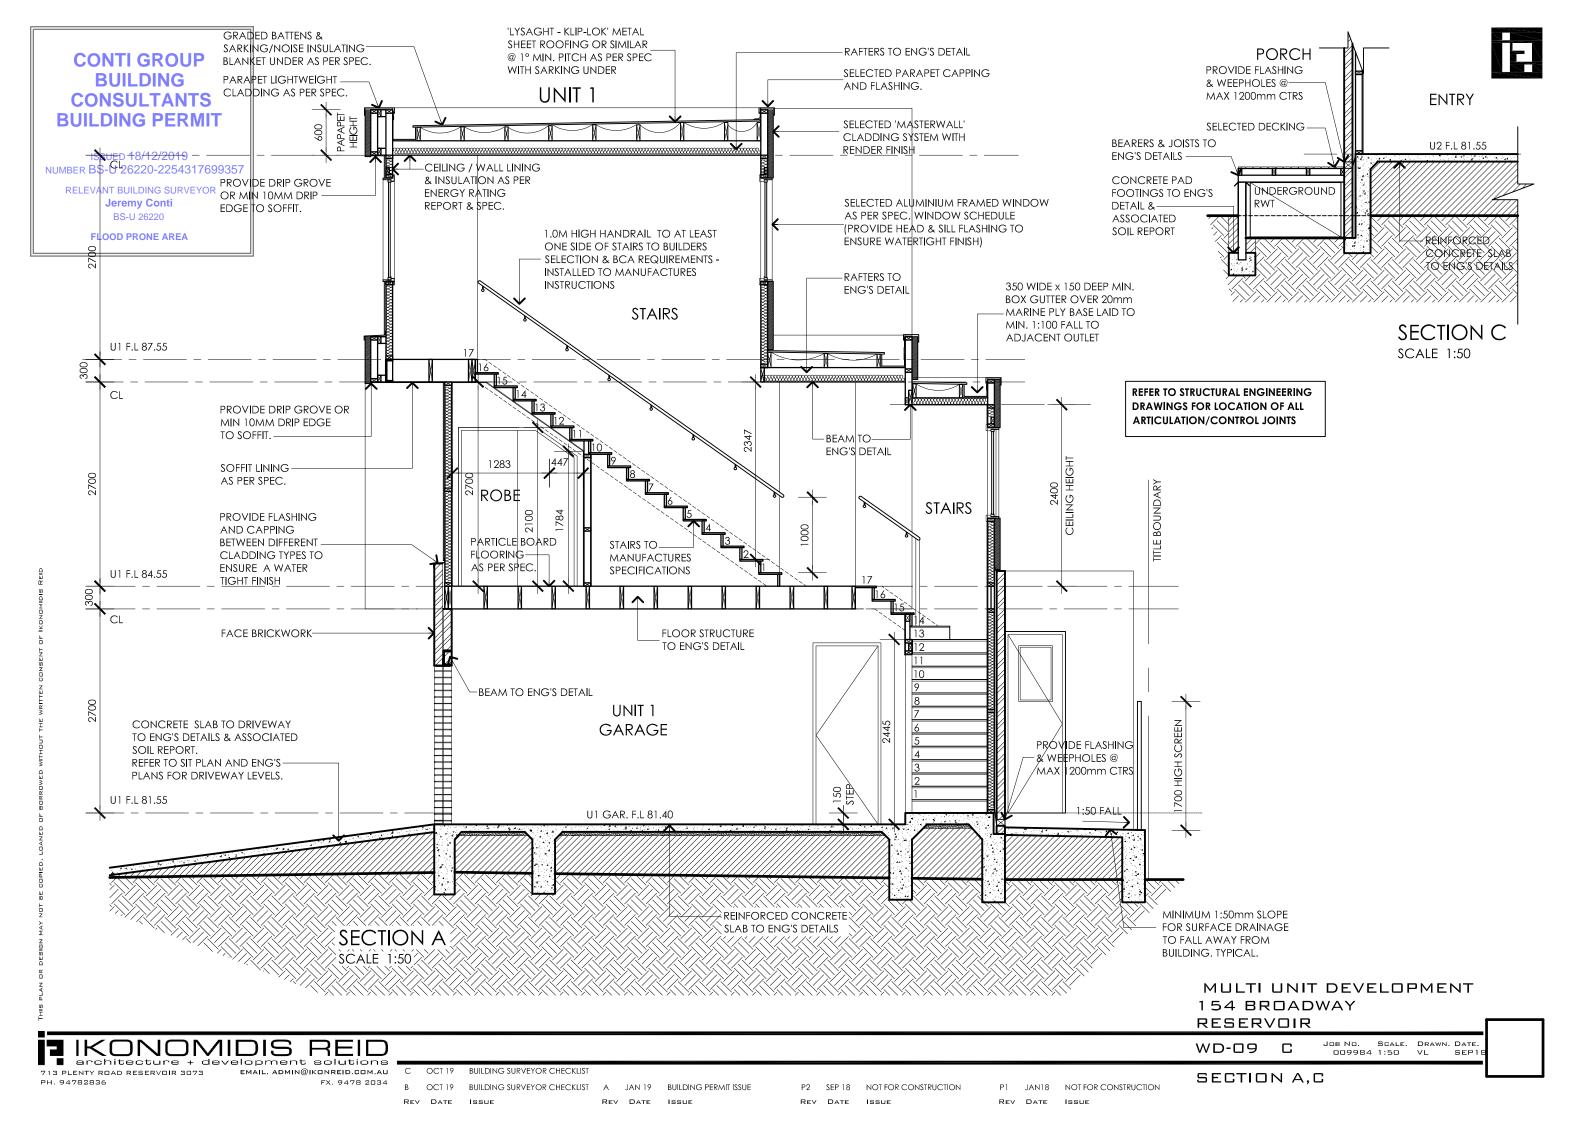
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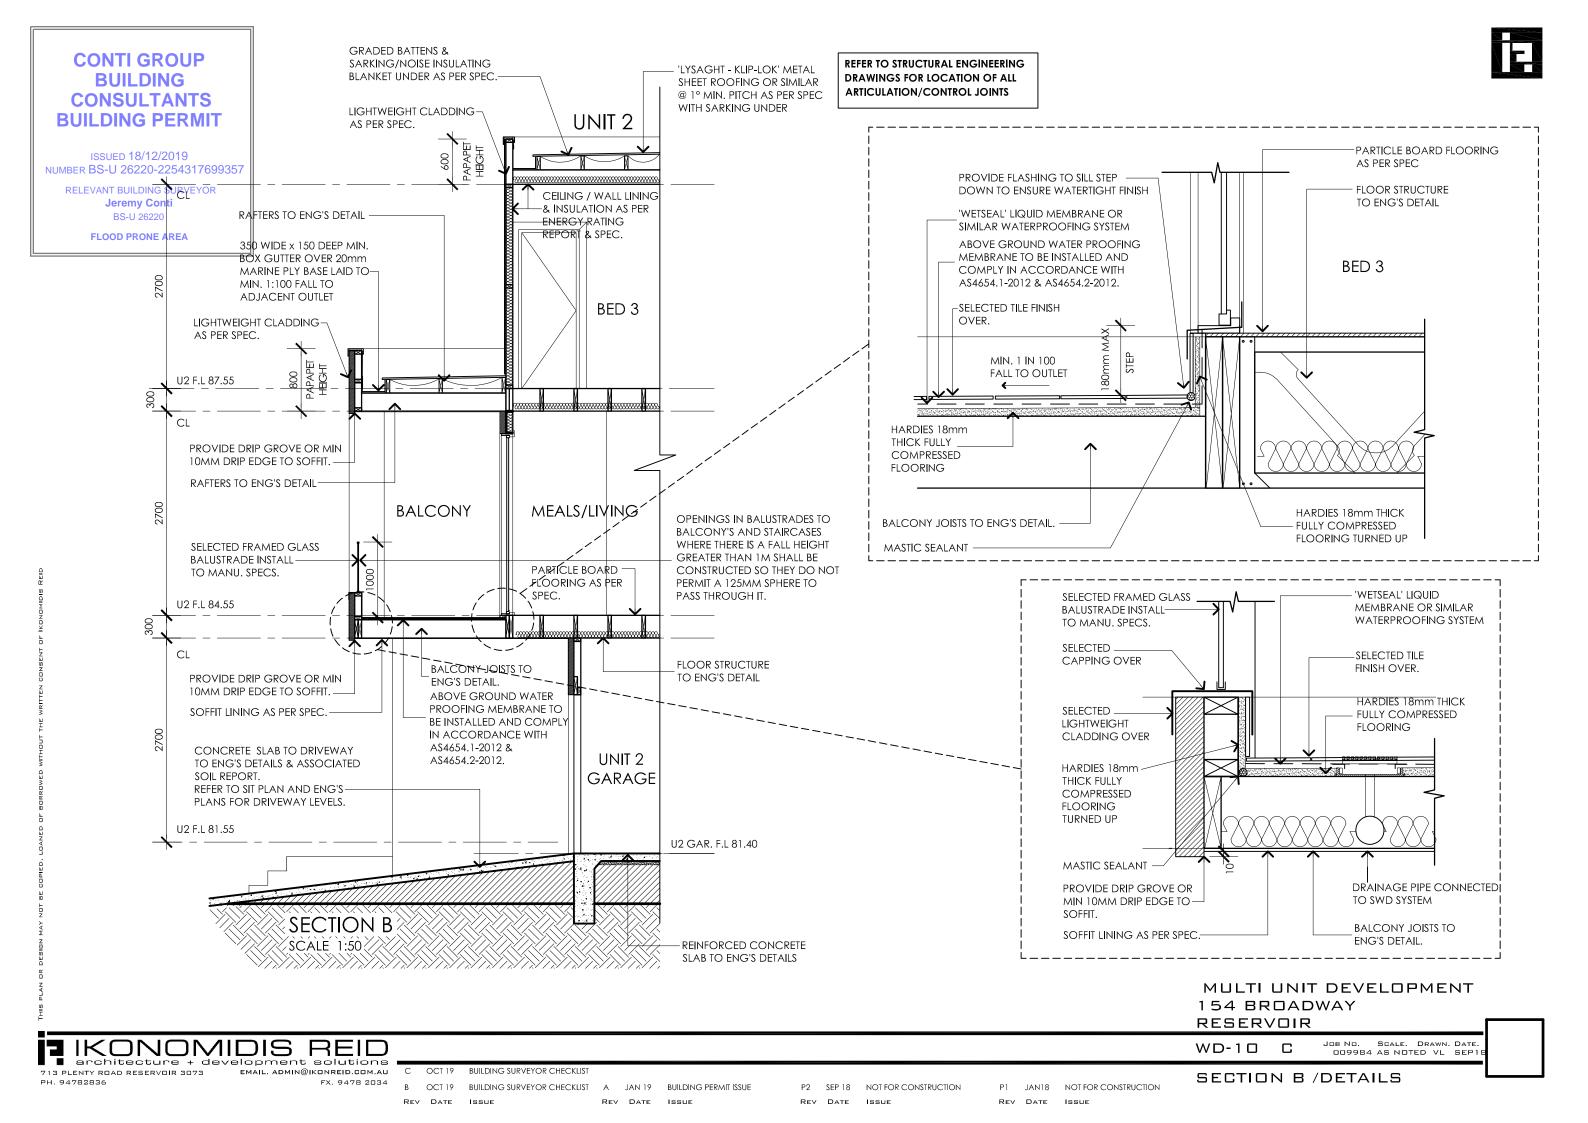
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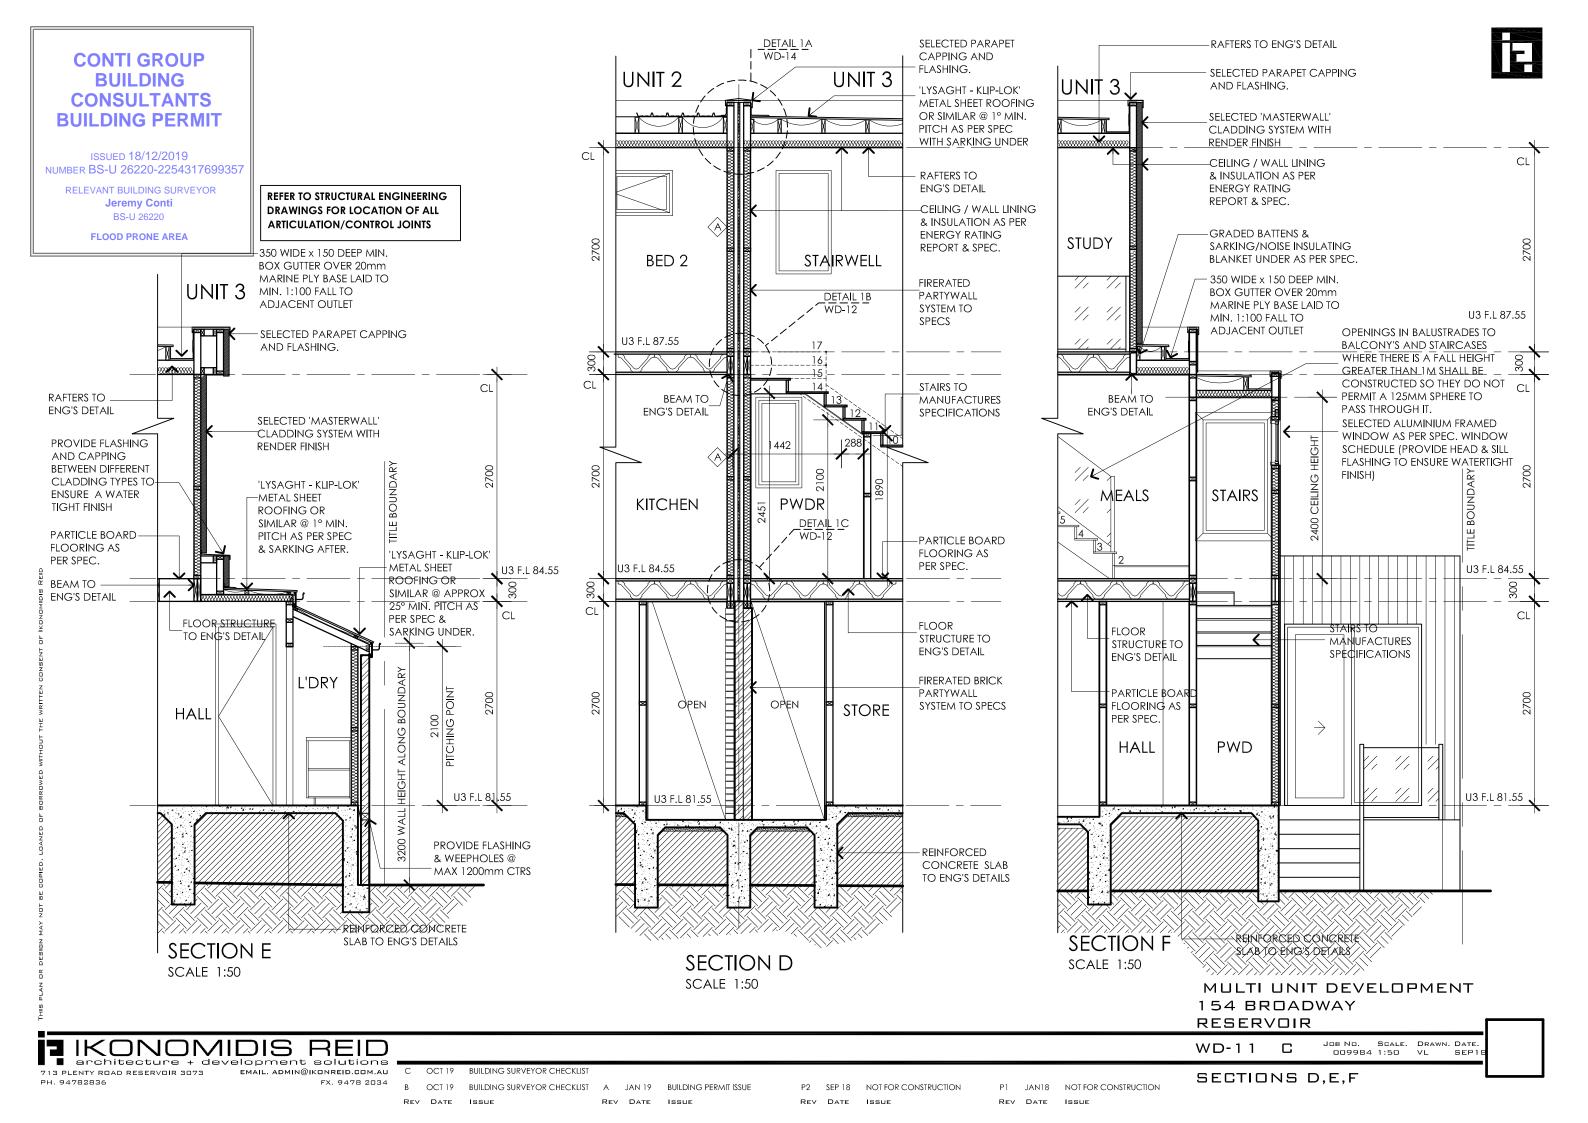
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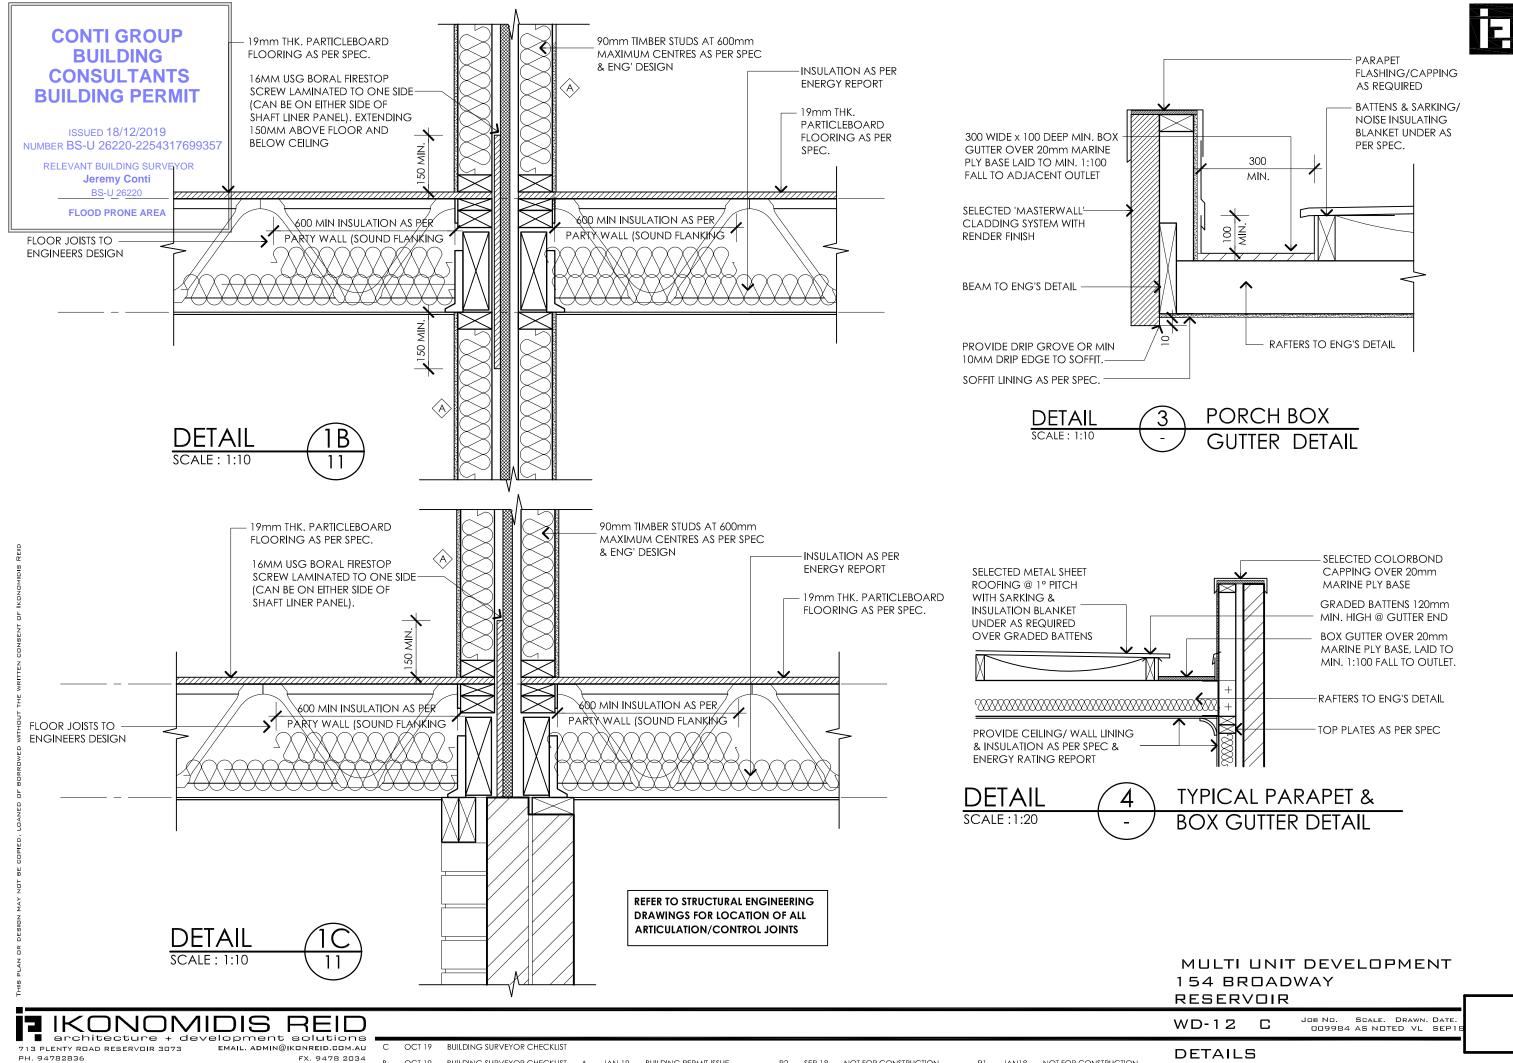













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CONTI GROUP BUILDING CONSULTANTS BUILDING PERMIT

ISSUED 18/12/2019 NUMBER BS-U 26220-2254317699357
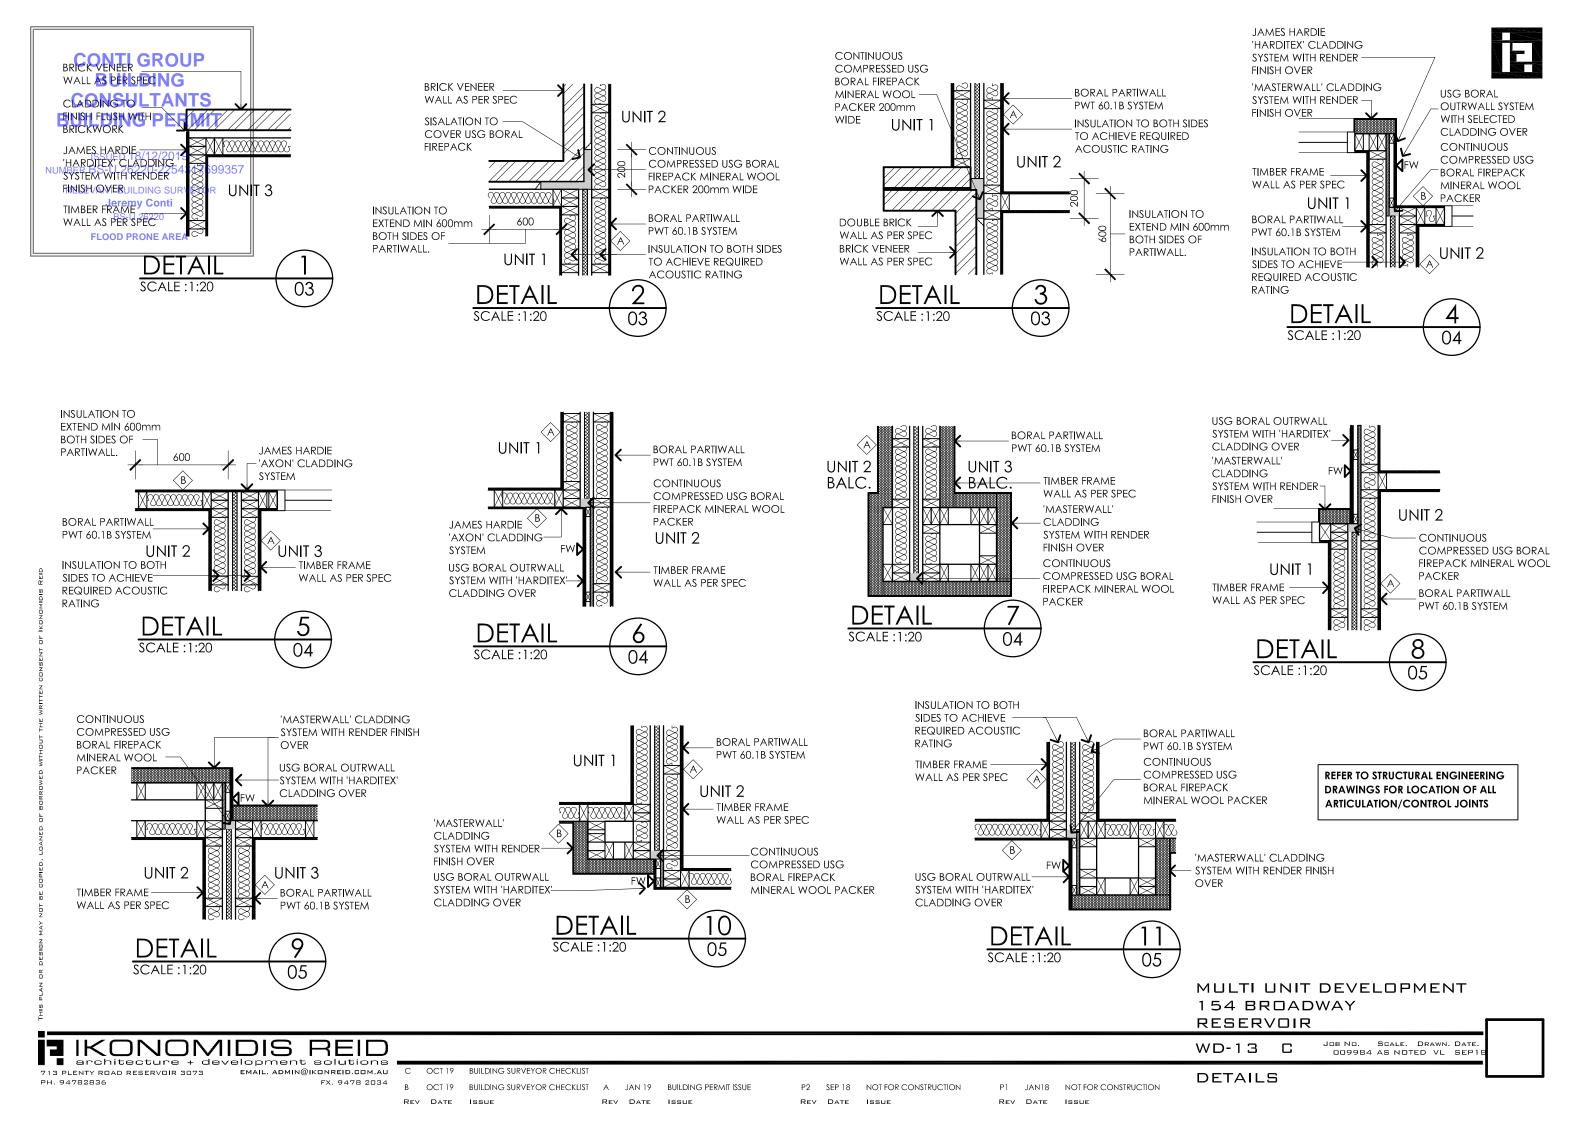
> RELEVANT BUILDING SURVEYOR **Jeremy Conti** BS-U 26220

> > FLOOD PRONE AREA


CONTINUOUS FLASHING/PARAPET COMPRESSED USG BORAL CAPPING TO ENSURE FIREPACK MINERAL WOOL WATER TIGHT FINISH 'LYSAGHT - KLIP-LOK' NOTE: PARAPET STUDS TO METAL SHEET ROOFING BE CONTINUOUS OR SIMILAR @ 1° MIN. RAFTERS TO ENG'S DESIGN PITCH AS PER SPEC WITH SARKING UNDER 600 MIN 600 MIN 16MM USG BORAL FIRESTOP 90mm TIMBER STUDS AT 600mm SCREW LAMINATED TO ONE SIDE-(CAN BE ON EITHER SIDE OF MAXIMUM CENTRES AS PER SPEC

REFER TO STRUCTURAL ENGINEERING DRAWINGS FOR LOCATION OF ALL ARTICULATION/CONTROL JOINTS

600mm WIDE MIN OF ADDITIONAL INSULATION AS PER RELEVANT WALL TYPE TO EACH SIDE OF PARTY WALL TO MAINTAIN ACOUSTIC RATING AS REQ'D FOR THE PARTICULAR WALL TYPE

& ENG' DESIGN **BORAL PARTIWALL**

PWT 60.1B SYSTEM

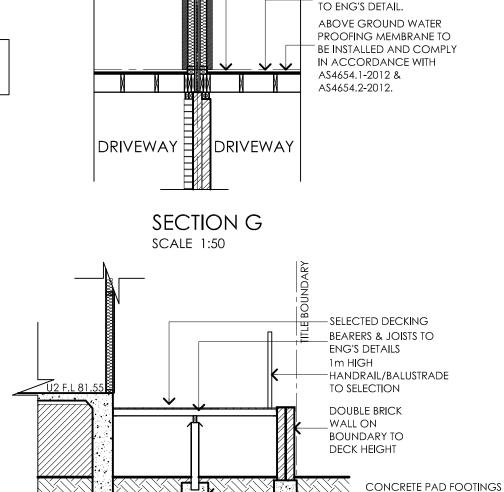

SECTION H

SCALE 1:50

UNIT 2

 $\langle A \rangle$

BALC.

MULTI UNIT DEVELOPMENT 154 BROADWAY RESERVOIR

TO ENG'S DETAIL & **ASSOCIATED** SOIL REPORT

WD-14

FLASHING/PARAPET CAPPING TO ENSURE

WATER TIGHT FINISH

'LYSAGHT - KLIP-LOK'

METAL SHEET ROOFING OR SIMILAR @ 1° MIN. PITCH AS PER SPEC

WITH SARKING UNDER

OF SOUNDSTOP LINING

FIRE RATED PARTYWALL

'WETSEAL' LIQUID MEMBRANE OR

SIMILAR WATERPROOFING SYSTEM

SYSTEM TO SPECS

BALCONY JOISTS

'MASTERWALL' CLADDING SYSTEM WITH

RENDER FINISH OVER TO BOTH SIDES IN LIEU

RAFTERS TO

ENG'S DETAIL

UNIT 3

BALC.

JOB NO. SCALE. DRAWN. DATE. 009984 AS NOTED VL SEP1

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SHAFT LINER PANEL). EXTENDING 150MM BELOW CEILING

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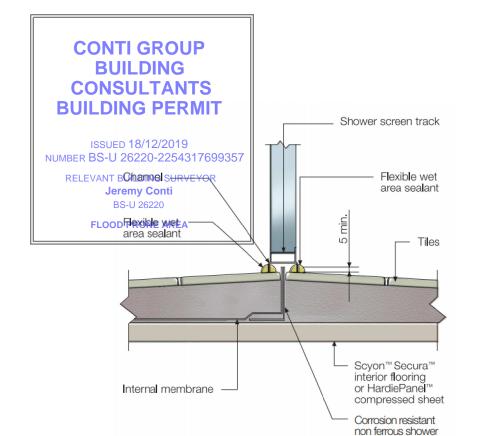
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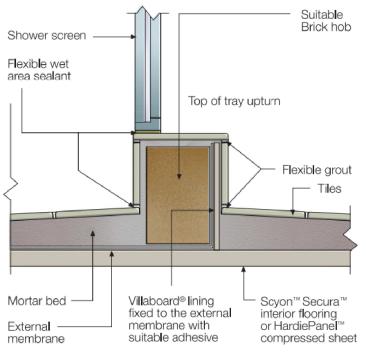
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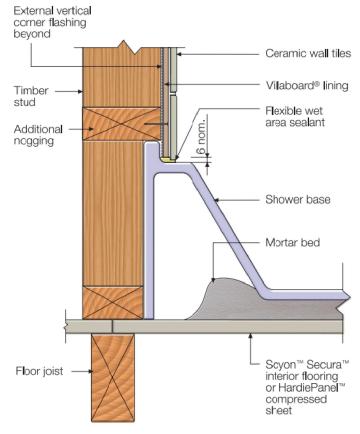
SECTION G, H & DETAIL



HOBLESS SHOWER

tray support angle






WATERPROOFING OF WET AREAS BATHROOM/ENSUITE:


WATERPROOF ENTIRE FLOOR, WALL / FLOOR JUNCTION & AROUND OPEN SHOWER AND FREE STANDING BATH AREA MINIMUM 1800MM HIGH & 1500MM FROM WATER OUTLET IN HORIZONTAL PLANE

LAUNDRY / WC: WATERPROOF WALL / FLOOR JUNCTIONS

BRICK HOB - EXTERNAL MEMBRANE



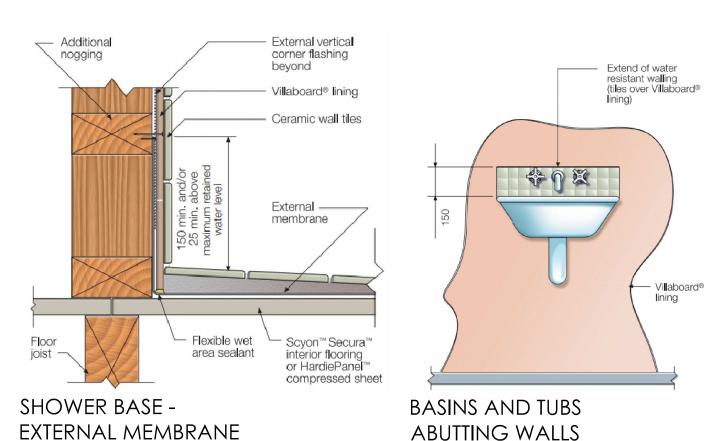

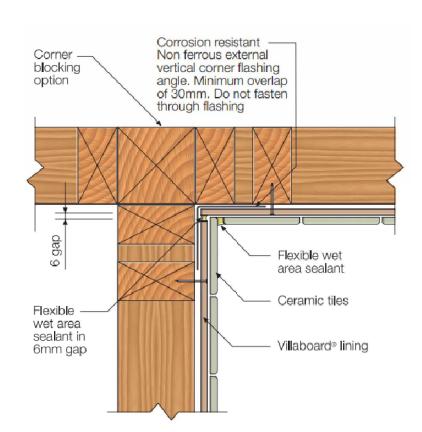

VERTICAL CORNER FLASHING FOR EXTERNAL MEMBRANE - SHOWER RECESS

> MULTI UNIT DEVELOPMENT 154 BROADWAY RESERVOIR

> > JOB NO. SCALE. DRAWN. DATE.

IKONOMIDIS REID

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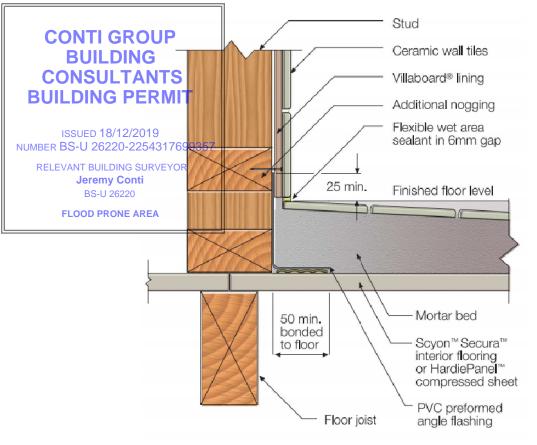
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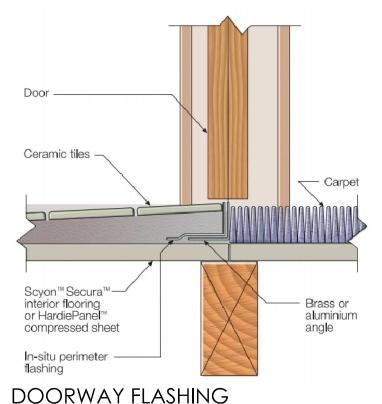
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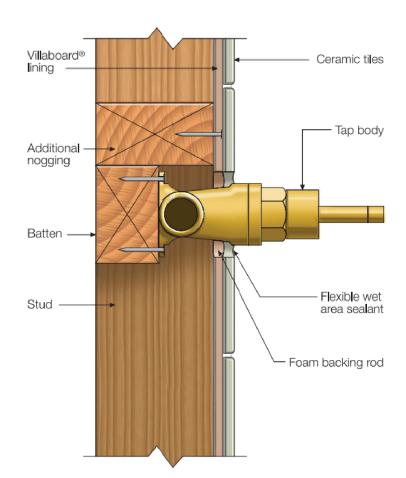
WET AREA DETAILS

WD-15










TAP PENETRATIONS TO SHOWER WALL

EXTERNAL PERIMETER FLASHING

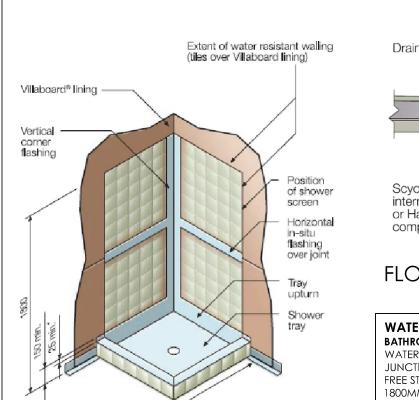

Graded mortar bed Drainage slots Floor tiles Internal membrane Scyon™ Secura™ internal flooring or HardiePanel™ Drainage flange compressed sheet

FLOOR PENETRATIONS

WATERPROOFING OF WET AREAS BATHROOM/ENSUITE:

WATERPROOF ENTIRE FLOOR, WALL / FLOOR JUNCTION & AROUND OPEN SHOWER AND FREE STANDING BATH AREA MINIMUM 1800MM HIGH & 1500MM FROM WATER OUTLET IN HORIZONTAL PLANE

LAUNDRY / WC: WATERPROOF WALL / FLOOR JUNCTIONS

ENCLOSED SHOWER

"Shower screen may increase max, retained water level above the height of the hob

(not required in shower recess)

MULTI UNIT DEVELOPMENT 154 BROADWAY RESERVOIR

WD-16

JOB NO. SCALE. DRAWN. DATE. 009984 AS NOTED VL SEP1

Perimeter flashing




CONTI GROUP BUILDING CONSULTANTS BUILDING PERMIT

ISSUED 18/12/2019 NUMBER BS-U 26220-2254317699357

RELEVANT BUILDING SURVEYOR **Jeremy Conti** BS-U 26220

FLOOD PRONE AREA

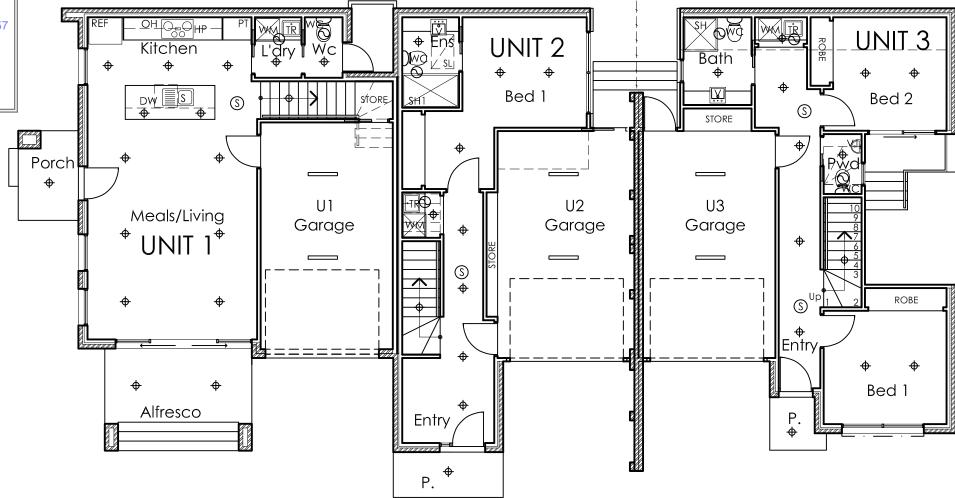

LIGHTING CALCULATION/SCHEDULE:

DWELLINGS 1-3 TO ACHIEVE 6 STAR RATING **ENERGY RATING FOR LIGHTING**

LIGHTING MUST HAVE A MAX. POWER DENSITY OF

- 5W/M2 FOR A DWELLING 4W/M2 FOR A PORCH
- 3W/M2 FOR A GARAGE
- ASSUMPTIONS FOR LIGHTING

713 PLENTY ROAD RESERVOIR 3073

♦ LED DOWNLIGHT OR SIMILAR 10 WATTS

- ♠ LED DOWNLIGHT OR SIMILAR 4 WATTS
- BATTEN LIGHT CFL LIGHT GLOBE OR SIMILAR 15 WATTS BATTEN LIGHT FLUORESCENT TUBE OR SIMILAR 18 WATTS

UNIT 1

309 WATTS

UNIT 2

ENSURE WATT FOR NOMINATED AREAS DOESN'T EXCEED MAX WATTS FOR THE DWELLING (GROUND FLOOR):-NOMINÁTED: 140 WATTS **228 WATTS** AREA: **45.66m2**

MAX WATTS FOR THE DWELLING (FIRST FLOOR):-**373 WATTS** AREA: **74.72m2** NOMINATED: 140 WATTS MAX WATTS FOR THE DWELLING (SECOND FLOOR):-

217 WATTS AREA: 43.54m2 NOMINATED: 100 WATTS MAX WATTS FOR THE GARAGE:-AREA: 21.00m2 NOMINATED: 36 WATTS **63 WATTS**

MAX WATTS FOR THE PORCH:-15 WATTS AREA: 3.77m2 MAX WATTS FOR THE PERGOLA:-

NOMINATED: 10 WATTS

NOMINATED: 20 WATTS

AREA: 77.41m2

ENSURE WATT FOR NOMINATED AREAS DOESN'T EXCEED MAX WATTS FOR THE DWELLING (GROUND FLOOR):-

172 WATTS NOMINATED: 100 WATTS AREA: 34.51m2 MAX WATTS FOR THE DWELLING (FIRST FLOOR):-NOMINATED: 130 WATTS **237 WATTS** AREA: **47.52m2**

MAX WATTS FOR THE DWELLING (SECOND FLOOR):-NOMINATED: 90 WATTS **230 WATTS** AREA: **46.12m2**

MAX WATTS FOR THE GARAGE:-**64 WATTS** AREA: 21.53m2 MAX WATTS FOR THE PORCH:-

13 WATTS AREA: **3.49m2** MAX WATTS FOR THE BALCONY:-45 WATTS AREA: 11.34m2 NOMINATED: 36 WATTS

NOMINATED: 10 WATTS NOMINATED: 20 WATTS

UNIT 3

ENSURE WATT FOR NOMINATED AREAS DOESN'T EXCEED MAX WATTS FOR THE DWELLING (GROUND FLOOR):-AREA: **43.51m2** NOMINATED: 120 WATTS 217 WATTS

MAX WATTS FOR THE DWELLING (FIRST FLOOR):-**NOMINATED: 90 WATTS 221 WATTS** AREA: **44.20m2**

MAX WATTS FOR THE DWELLING (SECOND FLOOR):-**154 WATTS** AREA: **30.93m2** NOMINATED: 70 WATTS MAX WATTS FOR THE GARAGE:-

NOMINATED: 36 WATTS **108 WATTS** AREA: 21.72m2 MAX WATTS FOR THE PORCH:-90 WATTS AREA: 18.05m2

MAX WATTS FOR THE BALCONY:-AREA: 9.47m2 47 WATTS

NOMINATED: 10 WATTS NOMINATED: 20 WATTS

- WHERE LAMPS ARE USED THAT HAVE A TRANSFORMER OR BALLAST, THE TRANSFORMER BALLAST MUST BE OF ELECTRICAL TYPE
- HALOGEN LAMPS MUST BE SEPARATELY SWITCHED FROM FLUORESCENT LAMPS
- OUTDOOR LIGHTING MUST BE CONTROLLED BY A DAY SENSOR OR HAVE AT LEAST 40 LUMENS/W
- TYPICAL LIGHTING PLAN PROVIDED MAY VARY DURING CONSTRUCTION TO OWNERS SELECTION (ENSURE WATTAGE DOES NOT EXCEED MAXIMUM WATTAGE ALLOWANCE SHOWN IN THE TABLE ABOVE IF VARIED DURING CONSTRUCTION)

MULTI UNIT DEVELOPMENT 154 BROADWAY RESERVOIR

JOB NO. SCALE. DRAWN. DATE. 009984 1:100 VL SEP1 WD-17



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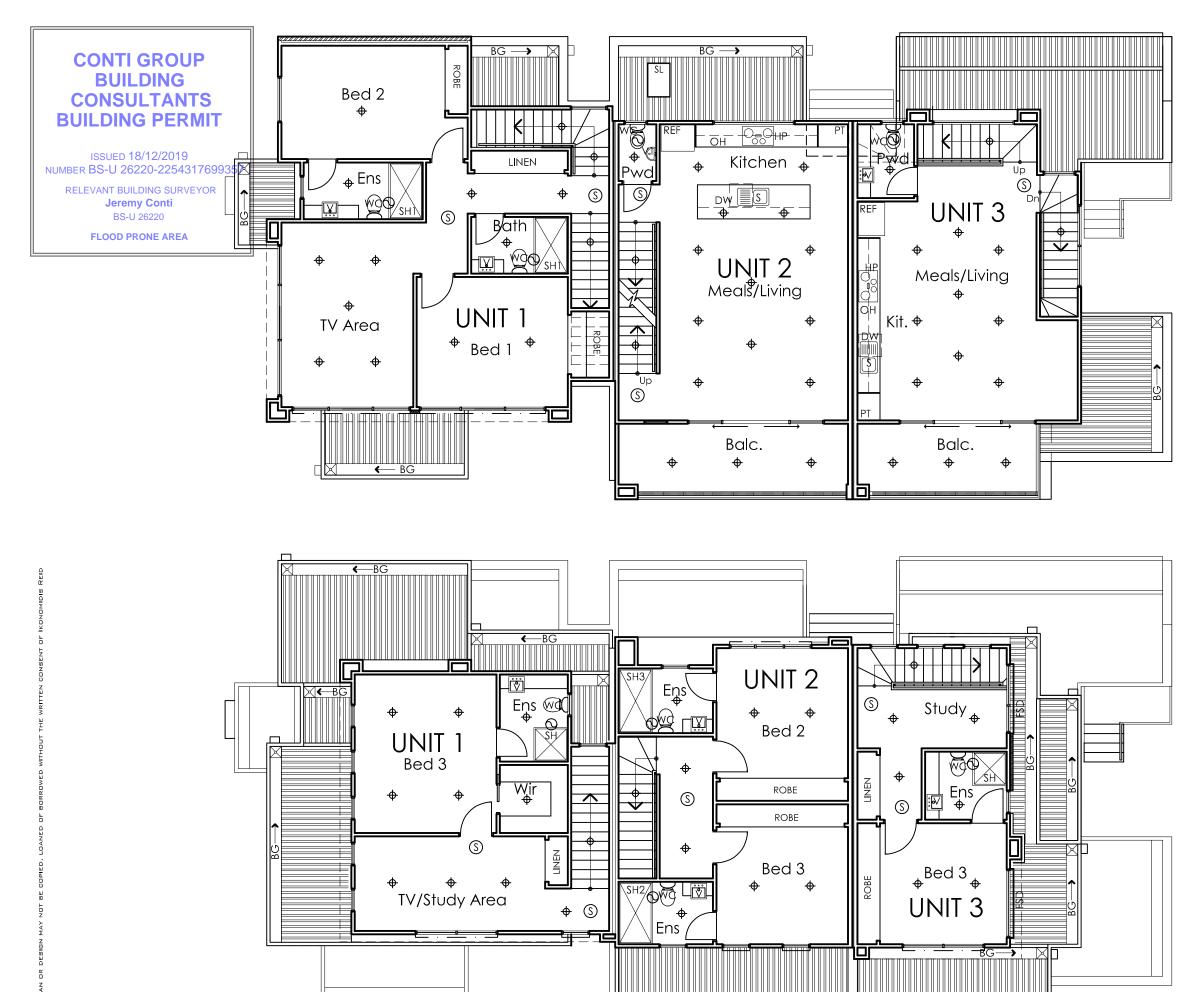
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LIGHTING PLAN GROUND FLOOR







MULTI UNIT DEVELOPMENT 154 BROADWAY RESERVOIR

JOB NO. SCALE. DRAWN. DATE. 009984 1:100 VL SEP1

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713 PLENTY ROAD RESERVOIR 3073 EMAIL. ADMIN@IKONREID.COM.AU C OCT 19 BUILDING SURVEYOR CHECKLIST

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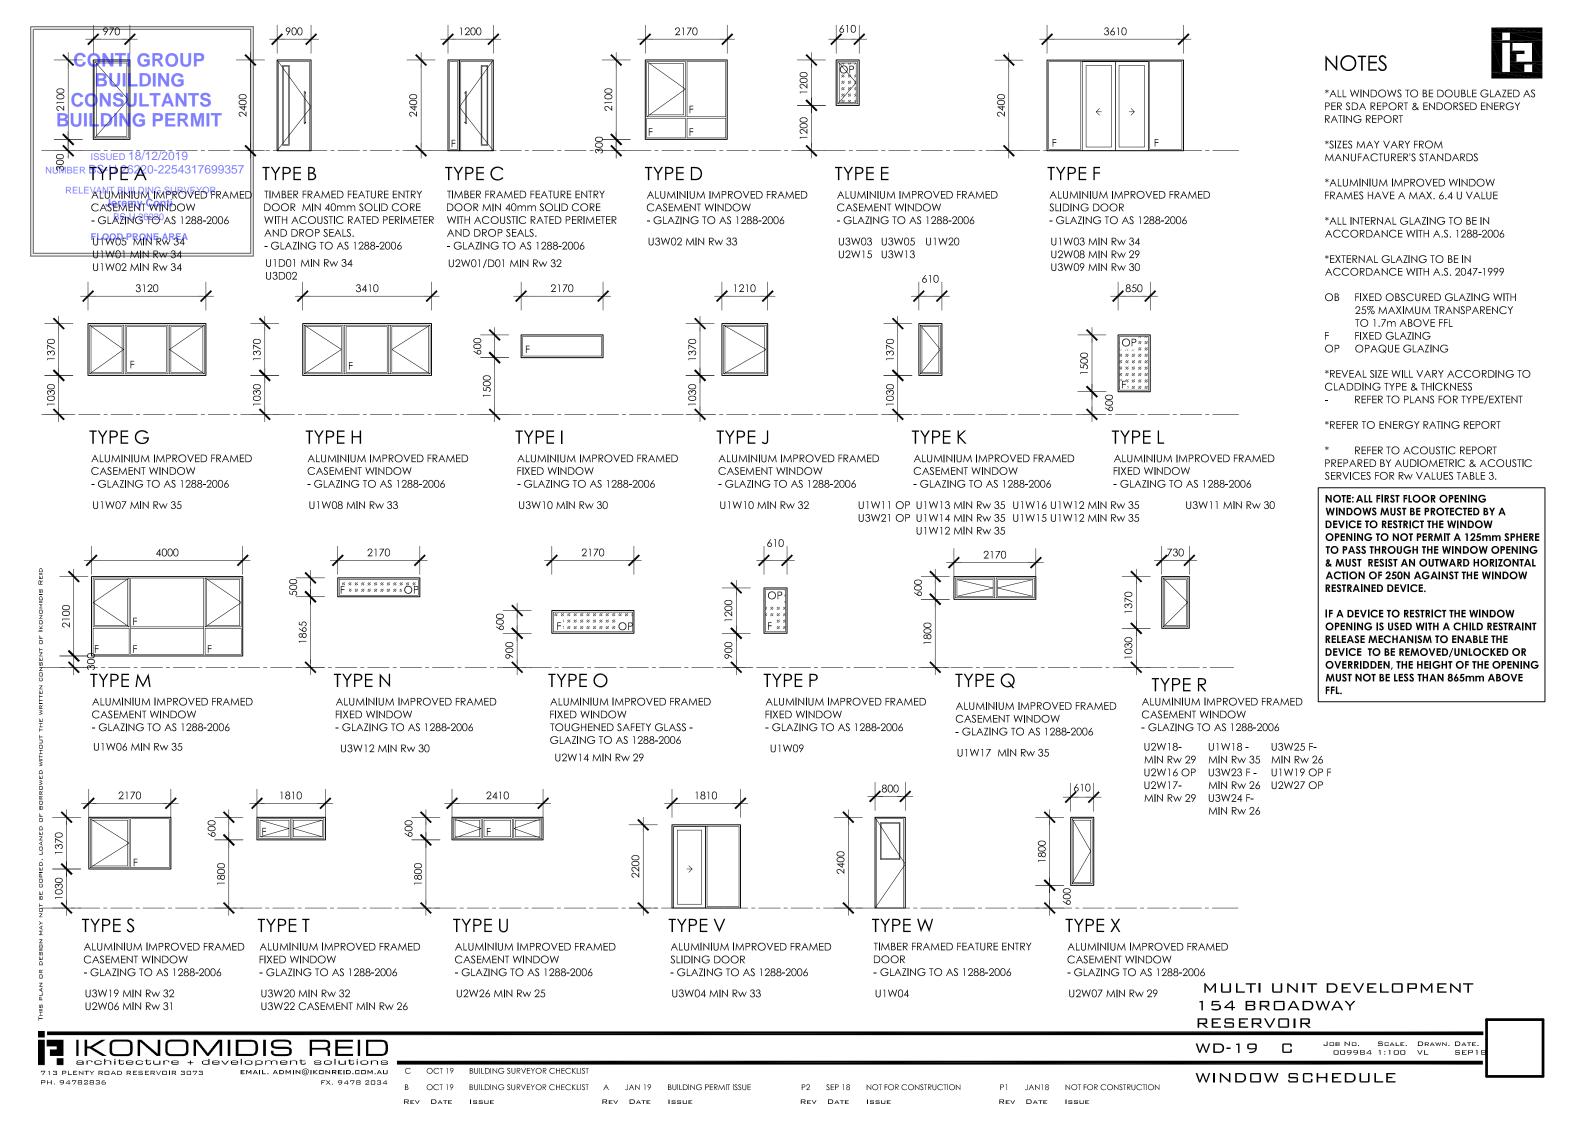
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LIGHTING PLAN FIRST & SECOND FLOOR

WD-18 C



ENERGY RATINGS

DWELLING TO ACHIEVE A MIN. OF 6.0 STARS AS REQUIRED UNDER RESCODE AT THE TIME OF THE PLANNING PERMIT BEING ISSUED.

REFER TO ENERGY RATING REPORT JOB No: 13861THE FIRSTRATE SOFTWARE SYSTEM WAS USED FOR THESE RATINGS THE FOLLOWING IS A SUMMARY FOR THIS DEVELOPMENT: -

UNIT 1:- 6.0 STAR\$8/12/2(113.2 MJ/m2 UNIT 2:- 6.2 STARS 20-22110 5 MJ/m2

REFER TO ENERGY RATING REPORT FOR DETAILS

ANY VARIATION TO THE SPECIFICATION MAY RESULT THE THE MINIMUM RATING NOT BEING ACHIEVED.

CONTACT THE ENERGY RATER IF THERE IS ANY HANGE TO THE SPECIFICATION

THE FOLLOWING HAS BEEN INCORPORATED INTO THE RATING FOR THIS DEVELOPMENT:-

FLOOR DETAILS

Suspended slab to ground floor structure with;

R2.0 insulation

Timber framed floor to first floor structure with;

R2.5 floor insulation to areas located above the garage and cantilevered floors.

WALL DETAILS

Units 1-3

Brick Veneer/Lightweight Cladding

R2.5 insulation plus reflective sarking/breathable vapour barrier fixed to

the external face of the studs.

same insulation as external walls

ROOF & CEILING DETAILS

Metal

R5.0 insulation laid directly above the ceiling plasterboard.

Plus 55mm blanket fixed to underside of metal roof sheets

WINDOWS, GLAZING & SHADING DETAILS FRAMES:

Aluminium frames are used throughout. GLAZING:

Double glazing is used throughout.

Window System

Ħ	Туре	ole	
5		U Value	SHGC+
WITHOUT	Awning	3.90	0.58
		3.59	0.66
ΛED	SI. Door	4.09	0.61
ő	Sashless	4.23	0.60
BOR	SI. Door Sashless SI. Window	4.20	0.62
4			

SKYLIGHT:

Generic double glazed

SHADINGS:

Holland blinds installed internally – allowed by SEAV. (This assumption is for regulatory purposes only.)

LIGHTING

The lamp power density or illumination power density of artificial lighting not to exceed:

-In a class 1 building (within the building), 5 W/m² -On a verandah or balcony attached to the class 1, 4 W/m²

-In a class 10 building (Garage, Shed...) 3 W/m² -Electric resistance space heating not to exceed

110 W/m² for living areas and 150 W/m² for bathrooms

713 PLENTY ROAD RESERVOIR 3073

AIR LEAKAGE

If used, Downlights are to be sealed (fitted with shrouds).

Self sealing Exhaust fans (Excluding IXL tastics).

Windows and sliding doors are fitted with weather seals.

External doors fitted with a weather-strip.

Gaps & Cracks around doors, windows and service penetrations are sealed – refer to information sheet attached.

Obstructions such as adjacent dwellings have been included in the above rating and assumed to be two-storeys at minimum setback (Unless noted otherwise)

Note:

The requirement for all new dwellings to be a 6-Star energy rating plus either a solar hot water system or a rainwater tank (min 2000 litre) connected to all sanitary flushing.

Reflective foil - only provides an insulating effect when the reflective side of the foil faces an air space, because it works by reducing radiant heat flow across this airspace. It is the existence of this airspace that provides an insulating effect. Any air-gap must be a minimum of 25mm to be effective. Air must not be allowed to leak from one side of the foil to the other - so gaps around penetrations must be taped and sealed.

Bulk insulation - cannot be compressed or it will not Dwelling internal walls adjoining the garage to have achieve its R value. Ensure all gaps in bulk insulated walls are filled by insulation.

> Comply with the Energy Safe Victoria electrical safety alert in relation to the installation of bulk insulation around downlights etc.

REFER TO SDA REPORT BY KEYSTONE ALLIANCE 13056 DATED AUG 2017 FOR FURTHER INFO/REQUIREMENTS

FLOOR FINISHES



CERAMIC TILES TO OWNER'S SELECTION

CARPET TO

FLOORBOARDS TO **OWNER'S SELECTION**



COLOURED CONCRETE DRIVEWAY/PATH

GENERAL SPECIFICATION

SOIL CLASSIFICATION REFER TO SOIL REPORT **CEILING HEIGHT** GROUND FLOOR 2700mm - FIRST FLOOR 2700mm SECOND FLOOR 2700mm

CONFIRM WITH TRUSS MANUFACTURER **ROOF LOAD WIDTH**

LYSAGHT 0.48 THICK KLIPLOCK METAL SHEET ROOFING @ 1° & APPROX 25° PITCH WITH SARKING & NOISE

INSULATION BLANKET UNDER

ROOFING MASS 40+ KG/M²

ROOFING TYPE

EXTERNAL WALLS 240 mm WIDE BRICK VENEER CONSTRUCTION FACE BRICKWORK TO EXTERNAL LEAF

INTERNAL LEAF TIMBER STUD WALL LINED WITH PLASTERBOARD **FOOTINGS** REFER TO ENGINEERS DRAWINGS

BOTTOM WALL PLATE BOTTOM PLATES TO BE SAME AS STUD CONTINUOUSLY SUPPORTED BY CONCRETE SLAB

OR SOLID BLOCKING

FOR STUDS WITH MAXIMUM HEIGHT OF 2.7m: STUDS

> LOWER STOREY LOADBEARING 90 x 35 MGP10 AT 450 CRS STUDS NOTCHED FOR BRACING 90 x 35 MGP10 NOGGINGS SINGLE / UPPER STOREY 90 x 35 MGP10 AT 450 CRS STUDS NOTCHED FOR BRACING 90 x 35 MGP10 NOGGINGS

ENSURE STUDS GREATER THAN 2.7m IN HEIGHT TO BE DESIGNED BY ENGINEER

METAL ANGLE/SPEEDBRACE AND **BRACING** PLYWOOD BRACING AS REQUIRED

TO AS 1684 & AS 2269

REFER TO ENG'S DRAWINGS

LOWER STOREY LOADBEARING TOP WALL PLATES 2/35 x 90 MGP10 JAMB STUDS

LINTELS REFER TO ENG'S DRAWINGS **ROOF FRAMING**

TIMBER TRUSSES AT 600 CTRS TO MANU DETAILS AND FIXING SPEC. - TRUSS DESIGN COMPS AND LAYOUT PLAN TO BE SUBMITTED AND APPROVED BY BUILDING SURVEYOR PRIOR TO FRAME INSPECTION FIXING TO COMPLY WITH LOCAL WIND CATEGORY

MIN. 120. x 35 MGP.10 GRADED BATTENS @ 900 CTS

ROOFING BATTENS (MIN. SIZE DETERMINED BY BOX GUTTER DEPTH) MIN. 70 x 35 MGP.10 BATTENS @ 900 CTS

DOWN PIPE 100 x 50 COLORBOND DOWNPIPES OR SIMILAR TO BUILDER'S SELECTION

FASCIA & COLORBOND NOVALINE OR SIMILAR BARGE BOARDS TO BUILDERS SELECTION

19mm STRUCTURAL PARTICALBOARD FIRST FLOOR FLOORING

CARPET, FLOATING FLOORBOARDS AND CERAMIC TILES FLOOR FINISHES TO OWNER'S SELECTION WHERE INDICATED ON PLAN

ROOFING LYSAGHT 0.48 THICK KLIPLOCK METAL SHEET ROOFING @ 1° & APPROX 25° PITCH WITH SARKING & NOISE

INSULATION BLANKET UNDER

EAVES LINING 4.5 MM FC SHEET OR SIMILAR 10 MM PLASTERBOARD INTERNAL WALL

10 MM WATER RESISTANT PLASTERBOARD TO WET AREAS

CEILING LINING 10 MM PLASTERBOARD (600 CTRS) ALUMINIUM FRAMED WINDOWS WITH WEATHERSTRIPS WINDOWS AND

REFER TO WINDOW SCHEDULE SLIDING DOORS

TO OWNER'S SELECTION - PROVIDE WEATHERSTRIP **EXTERNAL DOORS**

EAVES GUTTER PROVIDE SLOTTED OVERFLOW GUTTERING TYP.

WHERE DP'S CANNOT BE PROVIDED @ MAX 1200

FROM VALLEY LOCATIONS TYP.

MIN. 300W x 100D COLORBOND BOX GUTTER OR SIMILAR

UNLESS NOTED OTHERWISE TO BUILDERS' SELECTION WALL INSULATION REFER TO ENERGY RATING REPORT & GENERAL NOTE WD-01

ELECTRICAL TO AUTHORITY REQUIREMENTS

EXTERNAL PAINTING TO OWNERS SELECTION INTERNAL PAINTING TO OWNER'S SELECTION

BOX GUTTER

FLASHING

PLUMBING TO WATER AUTHORITY REQUIREMENTS

CUPBOARDS -TO OWNER'S SELECTION KITCHEN & BATHROOM

> ALL FLASHING TO BE INSTALLED IN ACCORDANCE WITH AS/NZS 2904-1995. BUILD IN APPROVED FLASHING AT ALL EXTERNAL OPENINGS. PROVIDE AND INSTALL ALL

NECESSARY CAPPINGS AND FLASHINGS OF COMPATIBLE MATERIALS TO THE ROOFING, ALL NEATLY FITTED, SEALED AND FIXED TO PREVENT THE ENTRY OF WATER INTO THE BUILDING. ALL WORK TO BE CARRIED OUT IN A

TRADESMAN LIKE MANNER AND IN ACCORDANCE WITH

THE BEST TRADE PRACTICES

RAINWATER HEAD MIN 300W X 200D X 250H COLORBOND

RAINWATER HEAD OR SIMILAR TO BUILDER'S SELECTION WITH MIN 100 X 50 OVERFLOW POP

SUMP TO BUILDER'S SELECTION

SPREADER TO BUILDER'S SELECTION

CAPPING COLORBOND TO BUILDER'S SELECTION

INTERNAL DOORS TO BUILDER'S SELECTION

SKIRTS & ARCH'S TO BUILDER'S SELECTION

FLOOR & WALL TILING TO ALL WET AREAS, TO OWNER'S SELECTION

ROOF INSULATION AS PER ENERGY RATING REPORT & GENERAL NOTE WD-01 ALL TIMBER FRAMING WORKS TO COMPLY WITH TIMBER FRAMING CODE AS 1684 - 2010

WIND CLASSIFICATION N1

REFER TO STRUCTURAL ENGINEERING DRAWINGS FOR BRACING DETAILS

GROSS BUILDING AREA / UNIT:

		UNIT 1	UNIT 2	UNIT 3
	GROUND FLOOR	52.42m2	39.69m2	50.27m2
	FIRST FLOOR	79.82m2	50.58m2	47.31m2
	SECOND FLOOR	46.62m2	49.73m2	33.64m2
	GARAGE	21.86m2	23.47m2	23.58m2
	BALCONY	-	12.57m2	9.91m2
	PORCH	3.16m2	3.49m2	1.80m2
	TOTAL	203.88m2 (21.94SQ)	179.53m2 (19.32SQ)	166.51m2 (17.92SQ)

MULTI UNIT DEVELOPMENT 154 BROADWAY RESERVOIR

WD-20

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SPECIFICATIONS